HISTORIC LEVEL 3 ALTERATION: 114 AUSTIN STREET

PROJECT LOCATION 114 AUSTIN STREET WORCESTER, MA 01609

CLIENT POLAR VIEWS 89 WEST MAIN STREET, UNIT 101 NORTHBOROUGH, MA 01532 MR DANIEL YARNIE

ABBREVIATIONS		
ACOUSTICAL CEILING TILE	A.C.T	MANUFACTURED
ACOUSTIC	ACST	MARBLE
ABOVE FINISHED FLOOR	AFF	MASONRY


ALUM

ARCHITECT ARCH AKCHIECI AVERAGE BEAM BOARD BRASS BRONZE BUILDING BUILT-IN CABINET CEILING CENTER LINE CENTIMETER CERAMIC BLT-IN CERAMIC CLEAR COLD WATER COLUMN CONCRETE CONCRETE MASONRY UNIT CONSTRUCTION CONTINUOUS CONTRACTOR CMU CONST CONT'S CONTR DEMO DEMOLITION DEMOLITION DETAIL DIAMETER DIMENSION DOOR DOWN DRAWING DRINKING FOUNTAIN EACH ELECTRIC ELECTRIC ELECTRIC WATER COOLER FOULD DIA OR EQUAL EQUIPMENT ESTIMATE EXISTING EXTERIOR EXIENTOR FABRICATE FEET FINISH FINISHED ALL OVER FIREPROOF FLOOR FLUORESCENT FULL SIZE FURNISH GAUGE GENERAL FLUOI GENERAL GLASS GYPSUM BOARE HARDWARE GYP BE HDW HARDWOOD HDW HEIGHT HOLLOW CORE HORIZONTAL HOT WATER INCH INSULATION INTERIOR INTERIOR JUNCTION BOX LAVATORY LIGHT LIGHTING LINEAR LINOLEUM MANUFACTURER

GALVANIZE GYPSUM WALL BOARD 9/3/2024 12:31

PM

ALUMINUM

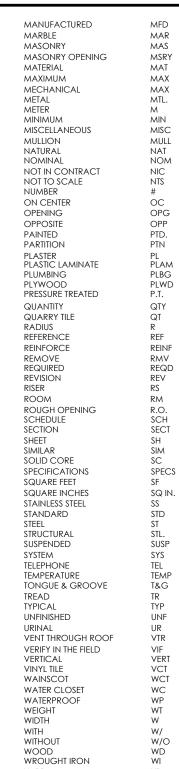

			LEGENE)
SYMBOLS		MATERIALS		
	Section		EARTH - LOAM EARTH - FILL	
	DETAIL		GRAVEL	
	EXTERIOR ELEVATION		CONCRETE	
234 A-1	INTERIOR ELEVATION		CONCRETE MASONRY BRICK	
(101)	DOOR INDICATION		BITUMINOUS CONCRETE	
$\langle A \rangle$	WINDOW INDICATION		BATT INSULATION	
A 	PARTITION TYPE		RIGID INSULATION	
123	ROOM NUMBER		wood - Finish	
A 9'-0"	CEILING REFERENCE		PLYWOOD - SMALL SCALE	
T.O. PLATE ELEV. 9'-0"	VERTICAL REF. POINT		ACOUSTICAL TILE	
			STEEL	
			ALUMINUM	

CIVIL ENGINEER

J.M. GRENIER ASSOCIATES, INC. 118 TURNPIKE ROAD, SUITE 200 SOUTHBOROUGH, MA 01772 MR. JOHN GRENIER JMGRENIER@TOWNISP.COM (T) 508.845.2500

DIXON SALO ARCHITECTS, INC. 300 MAIN STREET, FIRST FLOOR WORCESTER, MA 01608 MR. JESSE HILGENBERG

ARCHITECT

JHILGENBERG@DIXONSALOARCHITECTS.CC (T) 508.755.0533

DRAWING SYMBOLS EXIST WALL TO REMAIN DEMO EXIST WALL F PULL STATION \otimes EMERGENCY EXIT SIGN DH horn/strobe \triangleright STROBE Ð EMERGENCY BATTERY UNIT REMOTE HEAD Ø EMERGENCY EXIT SIGN W/BATTERY UNIT Х FIRE EXTINGUISHER С CARD READER ACCESS THERMOSTAT \bigcirc PHOTOELECTRIC SMOKE & CO DETECTOR $\langle S \rangle$ HEAT & CO DETECTOR Ð LOURESCENT LIGHTING FIXTURE SPRINKLER HEAD . HVAC GRILLE - RETURN \square HVAC - SUPPLY RECESSED DOWN LIGHT 0 M MOTION DETECTOR

LOCUS MAP



	LIST OF DRAWINGS	ARCHITECT: 372,5368 CTS.COM
	Interview Interview <thinterview< th=""></thinterview<>	DIXON SALOARCHITECT MORCESTER, MASSACHUSETT T) 508.755.0533 T) 508.755.0557 T) 508.755.0557 T) 508.755 T) 508.7557 T) 508.7577T) 508.7577 T) 508.7577T) 508.7577 T) 508.75777T) 508.75777 T) 508.7577777777777777777777777
	A-2.2AUSTIN STREET ELEVATIONA-2.3REAR ELEVATIONA-2.4PROPOSED MATERIAL PHOTOSA-2.5CARRIAGE HOUSE SECTIONA-2.6NEW BUILDING SECTIONA-6.0KITCHEN AND BATHROOM INTERIOR ELEVATIONS	ARCHITECT'S STAMP:
	A-8.0 DOOR & WINDOW TYPES, FINISH SCHEDULE <u>NOTE:</u> PORTIONS OF THE PROJECT ARE TO BE DESIGN-BUILD UNDER THE GENERAL CONTRACTOR. GENERAL CONTRACTOR TO PROVIDE ARCHITECT WITH STRUCTURAL, MECHANICAL, ELECTRICAL, FIRE PROTECTION, FIRE ALARM AND PLUMBING DRAWINGS FOR REVIEW BEFORE SUBMISSION FOR PERMIT.	
		ENGINEER:
MC		
		ENGINEER'S STAMP:
		GENERAL INFORMATION:
		SCHEMATIC 07.20.2023 DESIGN DEVELOPMENT 10.25.2023 BID N/A
		PERMIT 07.09.2024 CONSTRUCTION EXISTING CONDITIONS 4 4
		3 2 1 REVISION DATE
		DATE: 07.09.2024 SCALE: AS NOTED
		PROJECT: 2022.75 DRAWN: PL CHECKED: JGH
		PROJECT TITLE: 5-UNIT RESIDENTIAL IN HISTORIC DISTRICT 114 AUSTIN ST
		WORCESTER, MA 01609 SHEET TITLE: TITLE SHEET
		SHEET NUMBER:

GENERAL DEMOLITION NOTES

A. CONTRACTOR SHALL VISUALLY INSPECT THE SITE TO DETERMINE THE CONDITION OF EXISTING CONSTRUCTION AND FAMILIARIZE HIMSELF/HERSELF WITH THE PROPOSED WORK.

- 1. ALL WORK SHALL COMPLY WITH MUNICIPAL, STATE AND FEDERAL RULES AND REGULATIONS, LAWS AND ORDINANCES OF ALL THE AUTHORITIES HAVING JURISDICTION.
- 2. DISCONNECTION OF UTILITIES REQUIRED BY THE WORK SHALL BE PERFORMED BY QUALIFIED PERSONNEL.
- ALL WORK IS TO COMPLY WITH APPLICABLE PROVISIONS OF ANSI CODE FOR BUILDING CONSTRUCTION; ANS110.6, SAFETY OF DEMOLITION.
- 4. UTILITY LINES TO BE ABANDONED SHALL BE DISCONNECTED. REMOVE AS REQUIRED, AND/OR CAPPED OFF IN ACCORDANCE WITH APPLICABLE CODE AND REGULATIONS.
- 5. REMOVE ALL AREAS SHOWN DASHED (TYPICAL) ON DEMOLITION PLANS.
- CONTRACTOR TO PROTECT ALL EXISTING AREAS BEYOND LIMIT OF WORK OR ITEMS THAT ARE TO 6. REMAIN, AS REQUIRED.
- 7. COORDINATE DEMOLITION WORK WITH PROPOSED NEW WORK SHOWN ON PROJECT DRAWINGS.
- 8. THE GENERAL CONTRACTOR SHALL NOT INTERFERE WITH NORMAL ACTIVITY IN OR ADJACENT TO THE BUILDING, AND IS SHALL TAKE ALL NECESSARY SAFETY PRECAUTIONS TO PREVENT EXCESSIVE DUST, AND NOISE. ACCESS AND EGRESS TO AND FROM THE EXISTING BUILDING AS WELL AS FIRE PROTECTION IS TO BE MAINTAINED AT ALL TIMES THROUGHOUT THE ENTIRE CONSTRUCTION PROCESS.
- PROVIDE ALL TEMPORARY SHORING BRACING, FRAMING, AND PROTECTION OF EXISTING WORK TO 9. REMAIN BEFORE PROCEEDING WITH DEMOLITION AND DURING ALTERATION WORK.
- 10. PERFORM DEMOLITION WORK AS REQUIRED TO ACCOMMODATE NEW CONSTRUCTION. CONTRACTOR SHALL VERIFY THAT ALL REMOVED COMPONENTS ARE NOT STRUCTURAL, NOTIFY ARCHITECT BEFORE REMOVING ANY STRUCTURAL MEMBERS. NOTIFY ARCHITECT IN CASE OF DISCREPANCY BEFORE PROCEEDING WITH WORK.
- 11. IF DURING DEMOLITION CONDITIONS ARE REVEALED THAT MAY JEOPARDIZE THE INTEGRITY OF THE STRUCTURE OR PRECLUDE THE DESIGN INTENT, THE GENERAL CONTRACTOR SHALL NOTIFY THE ARCHITECT IMMEDIATELY.
- 12. DEMOLITION PLANS ASSUME THAT PORTIONS OF EXISTING WIRING, PLUMBING, EQUIPMENT, DUCTWORK, ETC., IN AREAS OF NEW WORK WILL BE REQUIRED TO BE REMOVED/RELOCATED TO MEET THE REQUIRED DESIGN PARAMETERS OF THE NEW WORK. PRIOR TO COMMENCING DEMOLITION/RELOCATION, CONTRACTOR SHALL VERIFY SPECIFIC CONDITIONS IN THE FIELD AND COORDINATE WITH GC AND ARCHITECT. (SEE M.E.P. DEMOLITION NOTES.)
- 13. BEFORE DISPOSING OF ANY REMOVED ITEMS, CONSULT WITH OWNER AND VERIFY POSSIBLE RE-USE, SALVAGE, OR DISPOSAL OF ANY EXISTING ITEMS AND EQUIPMENT, INCLUDING BUT NOT LIMITED TO, PLUMBING, FIXTURES, EQUIPMENT, LIGHT FIXTURES AND DOORS, ETC.

B. CUTTING AND PATCHING

- 14. GENERAL CONTRACTOR IS RESPONSIBLE FOR COORDINATION OF ALL SUBCONTRACTORS, DEMOLITION CUTTING AND PATCHING
- 15. ALL PARTITIONS, FLOORS, CEILINGS OR ITEMS TO BE REMOVED SHALL BE CLEANLY CUT BACK TO THE LIMITS SHOWN ON THE PLANS, SECTIONS, AND DETAILS OR AS DIRECTED BY THE ARCHITECT.
- 16. ALL EXISTING FLOORS, WALLS, AND CEILINGS AFFECTED BY NEW WALL LOCATIONS ARE TO BE PATCHED AND REPAIRED AS NECESSARY TO PROVIDE A SMOOTH UN-NOTICEABLE TRANSITION OF NEW AND EXISTING MATERIALS AND SURFACES.
- 17. PROVIDE CUTTING AND PATCHING AS REQUIRED FOR ALL DEMOLITION AND ALTERATION WORK. CUTTING AND PATCHING INCLUDE CUTTING INTO OR THROUGH TO PROVIDE FOR THE INSTALLATION OR PERFORMANCE OF OTHER WORK, AND THE SUBSEQUENT FITTING AND PATCHING REQUIRED TO RESTORE THE CUT SURFACES TO THEIR ORIGINAL CONDITION.
- REMOVE EXISTING INTERIOR FINISHES AND MATERIALS AS REQUIRED TO ACCOMMODATE NEW WORK. 19. ALL ITEMS ARE TO BE REMOVED IN A MANNER SO AS TO NOT DAMAGE THE EXISTING MATERIALS OR FINISHES THAT ARE TO REMAIN OR BE REINSTALLED.
- 20. PERFORM DEMOLITION WORK CAREFULLY. REMOVE MASONRY, STEEL, CONCRETE, WALLS AND OTHER STRUCTURAL ELEMENTS IN SMALL SECTIONS. REMOVE THESE MATERIALS TO A CLEANLY CUT, STRAIGHT LINE, ACCURATELY ESTABLISHED.
- 21. REMOVE FROM THE SITE AND DISPOSE OF LEGALLY, ALL EXISTING MATERIALS, DEMOLITION DEBRIS, TRASH, RUBBISH AND ITEMS THAT WILL NOT BE USED IN THE NEW WORK OR WILL NOT BE REUSED BY THE OWNER. STORAGE OF DEBRIS WILL NOT BE PERMITTED. ALL DEBRIS TO BE REMOVED AND DISPOSED OF IN ACCORDANCE WITH STATE AND LOCAL REGULATIONS.
- 22. COORDINATE REMOVAL OF ANY RATED ASSEMBLIES WITH LOCAL OFFICIALS BEFORE COMMENCING WORK.

C. M.E.P. DEMOLITION NOTES

- 23. SEE ELECTRICAL, HVAC, PLUMBING AND FIRE PROTECTION DRAWINGS FOR LOCATION OF NEW UTILITIES AND DEMOLITION OF EXISTING WORK NOT SHOWN ON THESE PLANS. GC TO COORDINATE ALL WORK WITH SUBCONTRACTORS.
- 24. WHERE EXISTING ELECTRICAL DEVICES OCCUR IN PARTITIONS INDICATED TO BE REMOVED, THE WIRING SHALL BE REMOVED, ALL ELECTRICAL LINES BEING DISCONNECTED SHALL BE ADEQUATELY TRACED AND RECONNECTED AS REQUIRED TO ENSURE PROPER FUNCTION FOR THE ADJACENT AREAS AND TO ENSURE PROPER FUNCTION OF THE EXISTING BUILDING EQUIPMENT OR SYSTEM TO REMAIN, ELECTRICAL CONTRACTOR TO VERIFY ALL ELECTRICAL SYSTEMS PRIOR TO THE COMMENCEMENT OF WORK.
- 25. WHERE EXISTING PLUMBING LINES ARE TO BE REWORKED OR REMOVED, ALL PLUMBING LINES BEING DISCONNECTED SHALL BE ADEQUATELY TRACED AND RECONNECTED AS REQUIRED TO ENSURE PROPER FUNCTION FOR THE ADJACENT AREAS AND TO ENSURE PROPER FUNCTION OF THE EXISTING BUILDING EQUIPMENT TO REMAIN IN PLACE.
- 26. WHERE EXISTING HVAC LINES, DUCTWORK, ETC. ARE TO BE REWORKED, ALL LINES AND EQUIPMENT BEING DISCONNECTED SHOULD BE ADEQUATELY TRACED AND RECONNECTED AS REQUIRED TO ENSURE PROPER FUNCTION FOR THE ADJACENT AREAS AND TO ENSURE PROPER FUNCTION TO THE EXISTING BUILDING EQUIPMENT OR SYSTEMS TO REMAIN.
- 27. COORDINATE WITH MECHANICAL AND ELECTRICAL DRAWINGS FOR LOCATIONS OF ALL NEW PENETRATIONS THRU ROOF, FLOORS, WALLS, AND CEILINGS.

D. CLEANING

28. CONTRACTOR IS FULLY RESPONSIBLE FOR THE CLEANING AND PREPARING OF ALL FLOOR, WALL AND CEILING SURFACES FOR THE INSTALLATION OF NEW MATERIALS AS SCHEDULED, UTILITIES, HVAC AND ELECT. SYSTEMS EQUIPMENT, ETC. AFTER DEMO CLEAN-UP.

OTHER: REMINDERS/SPECIFIC TO INDIVIDUAL PROJECTS

- 29. EXISTING LARGE FLOOR OPENINGS TO BE FILLED ARE INDICATED, SMALLER PIPE HOLES, ETC. TO BE FILLED ARE NOT INDICATED ON THE DRAWINGS. REFER TO DETAILS FOR REQUIREMENTS FOR FILLING SAID OPENINGS.
- 30. ALL EXISTING COLUMNS TO REMAIN UNLESS NOTED.
- 31. ALL EXPOSED UNUSED PIPING AND CONDUITS SHALL BE REMOVED BY THE GENERAL CONTRACTOR. SEE SPECIFICATIONS FOR CAPPING.

GENERAL CONSTRUCTION NOTES

- 1. ALL WORK IS TO BE PERFORMED IN PROFESSIONAL AND WORKMANLIKE MANNER, IN ACCORDANCE STATE BUILDING CODE, THE AMERICAN NATIONAL STANDARD (ANSI), THE INTERNATIONAL ENERGY CODE (IPC), THE INTERNATIONAL MECHANICAL CODE (IMC), AND THE NATIONAL FIRE PROTECTION STANDARDS, AS WELL AS ALL LOCAL REGULATIONS GOVERING THE PROJECT.
- 2. CONTRACTOR TO VISIT SITE AND TO VERIFY ALL DIMENSIONS AND CONDITIONS IN THE FIELD, AND REPORT ALL DISCREPANCIES TO ARCHITECT, PRIOR TO PROCEEDING WITH WORK.
- 3. ALL MATERIALS USED ON THIS PROJECT SHALL BE IN COMPLIANCE WITH THE APPLICABLE INTERNATIONAL BUILDING CODE.
- 4. THE CONTRACTOR SHALL MAINTAIN COMPLETE AND UP-TO-DATE DRAWINGS AT THE JOB SITE, AND SHALL SUBMIT ACCURATE AS-BUILT DRAWINGS TO ARCHITECT AND OWNER AT END OF PROJECT.
- 5. THE INTENTION OF THE CONTRACT DOCUMENTS IS TO INCLUDE ALL LABOR, MATERIALS, EQUIPMENT AND OTHER ITEMS NECESSARY FOR THE PROPER EXECUTION AND COMPLETION OF THE WORK.
- 6. BY EXECUTING THE CONTRACT, THE CONTRACTOR REPRESENTS THAT THEY HAVE VISITED THE SITE AND
- 7. THE ARCHITECT WILL HAVE AUTHORITY TO REJECT WORK WHICH DOES NOT CONFORM TO THE CONTRACT DOCUMENTS.
- THE CONTRACTOR SHALL BE SOLELY RESPONSIBLE FOR ALL CONSTRUCTION MEANS, METHODS, SUB-CONTRACTORS.
- 9. EACH CONTRACTOR SHALL PERFORM ALL REQUIRED CUTTING AND PATCHING FOR THEIR OWN TRADE, UNLESS OTHERWISE NOTED.
- 10. DRAWINGS SHALL NOT BE SCALED TO OBTAIN DIMENSIONS.
- 11. CONTRACTOR SHALL PROPERLY PROTECT AND MAKE SAFE WORK PREMISES.
- 12. THE CONTRACTOR SHALL KEEP THE WORKSITE CLEAN AND TIDY, AND AT ALL TIMES SHALL KEEP THE
- 13. ALL EXITS SHALL BE KEPT READILY ACCESSIBLE AND UNOBSTRUCTED AT ALL TIMES AND SHALL MAINTAIN REQUIRED EMERGENCY EGRESS DURING CONSTRUCTION.
- 14. THE CONTRACTOR SHALL INDEMNIFY AND HOLD HARMLESS THE OWNER AND THE ARCHITECT, AND
- 15. THE CONTRACTOR SHALL PAY ALL FEES AND SECURE PERMITS FROM ALL AGENCIES HAVING AUTHORITY HAVING JURISDICTION.
- 16. WEATHER PROTECTION: THE CONTRACTOR SHALL AT ALL TIMES PROVIDE PROTECTION AGAINST THE FIXTURES FROM INJURY OR DAMAGE.
- 17. THE CONTRACTOR SHALL PROTECT ALL AREAS OUTSIDE THE CONTRACT LIMITS AND RESTORE ALL SUCH PROPERTY TO ITS CONDITION PRIOR TO THE START OF THE WORK.
- 18. DAMAGE: ALL WORK DAMAGED BY FAILURE TO PROVIDE PROTECTION SHALL BE REMOVED AND REPLACED WITH NEW WORK AT THE CONTRACTORS EXPENSE. THE CONTRACTOR SHALL THEIR WORK.
- 19. ALL FINISHES SHALL COMPLY WITH THE LIMITS FOR FIRE RESISTANCE/FLAMMABILITY AS SPECIFIED IN THE APPLICABLE INTERNATIONAL BUILDING CODE.
- 20. ALL DEMOLITION AND RELOCATING OF EXISTING MEP SYSTEMS EFFECTING NEW PLUMBING, HVAC, AND ELECTRICAL SYSTEMS SHALL BE COORDINATED WITH RESPECTIVE SUBCONTRACTORS. RELOCATE/REWORK ALL ACTIVE MECHANICAL AND ELECTRICAL LINES WHERE REQUIRED DUE TO ATTENTION OF THE ARCHITECT BEFORE COMMENCING WORK.
- 21. CONTRACTORS SHALL COORDINATE WITH PROPERTY MANAGER AS REQUIRED WHEN ITEMS OF NEW AREA OF WORK REPLACE AND RESTORE FINISHES TO MATCH AFTER COMPLETION OF WORK.
- 22. PROVIDE ALL BLOCKING REQUIRED TO INSTALL MILLWORK, EQUIPMENT, CASEWORK, GRAB BARS, RAILINGS, ETC. TYPE AND LOCATION SHALL BE SUBJECT TO REVIEW BY ARCHITECT.
- 23. FOAM IN PLACE INSULATION FOR SMALL GAPS AND VOIDS.
- 24. CAULK ALL JOINTS OF DISSIMILAR MATERIALS.
- 25. PLAN DIMENSIONS ARE TO FACE OF PARTITION AT INTERIOR AND FACE OF FOUNDATION AT EXTERIOR, UNLESS OTHERWISE NOTED.
- 26. REFER TO OWNERS ENVIRONMENTAL REPORT REGARDING CONTAMINANTS AND ASBESTOS ON THE PROJECT SITE/BUILDING.

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WITH ALL APPLICABLE FEDERAL & STATE CODES, INCLUDING THE INTERNATIONAL BUILDING CODE (IBC). THESE INCLUDE, BUT ARE NOT LIMITED TO, THE INTERNATIONAL EXISTING BUILDING CODE (IEBC), MASS CONSERVATION CODE (IECC), THE NATIONAL ELECTRIC CODE (NEC), THE INTERNATIONAL PLUMBING

HAVE FAMILIARIZED THEM SELF WITH THE CONDITIONS UNDER WHICH THE WORK IS TO BE PERFORMED.

8. THE CONTRACTOR SHALL SUPERVISE AND DIRECT THE WORK, USING THEIR BEST SKILLS AND ATTENTION. TECHNIQUES, SEQUENCES, PROCEDURES, & SHORING, AND FOR COORDINATING THE WORK OF ALL

PREMISES FREE FROM ACCUMULATION OF WASTE MATERIALS OR TRASH CAUSED BY THEIR OPERATIONS.

THEIR AGENTS AND EMPLOYEES, FROM AND AGAINST ANY CLAIMS, DAMAGES, LOSSES AND EXPENSES INCLUDING ATTORNEY'S FEES ARISING OUT OF OR RESULTING FROM THE PERFORMANCES OF THE WORK.


JURISDICTION AND AT COMPLETION SHALL SEE THAT THE PROJECT IS SIGNED OFF BY THE APPROPRIATE

RAIN, WIND, STORM, FROST, OR HEAT SO AS TO MAINTAIN ALL WORK MATERIALS, APPARATUS, AND


UNCONDITIONALLY GUARANTEE ALL MATERIALS AND WORKMANSHIP UNTIL THE DATE OF OWNER'S ACCEPTANCE AND SHALL REPLACE ANY DEFECTIVE WORK WITHIN THAT PERIOD WITHOUT EXPENSES TO THE OWNER AND PAY FOR ALL DAMAGES TO OTHER PARTS OF THE BUILDING CAUSED BY REPAIR OF


REMOVALS AND NEW LAYOUT. MODIFICATIONS FROM THE DRAWINGS SHALL BE BROUGHT TO THE


PLUMBING WORK REQUIRE ACCESS TO ADJACENT COMMON AREAS, AND TENANT SPACES OUTSIDE

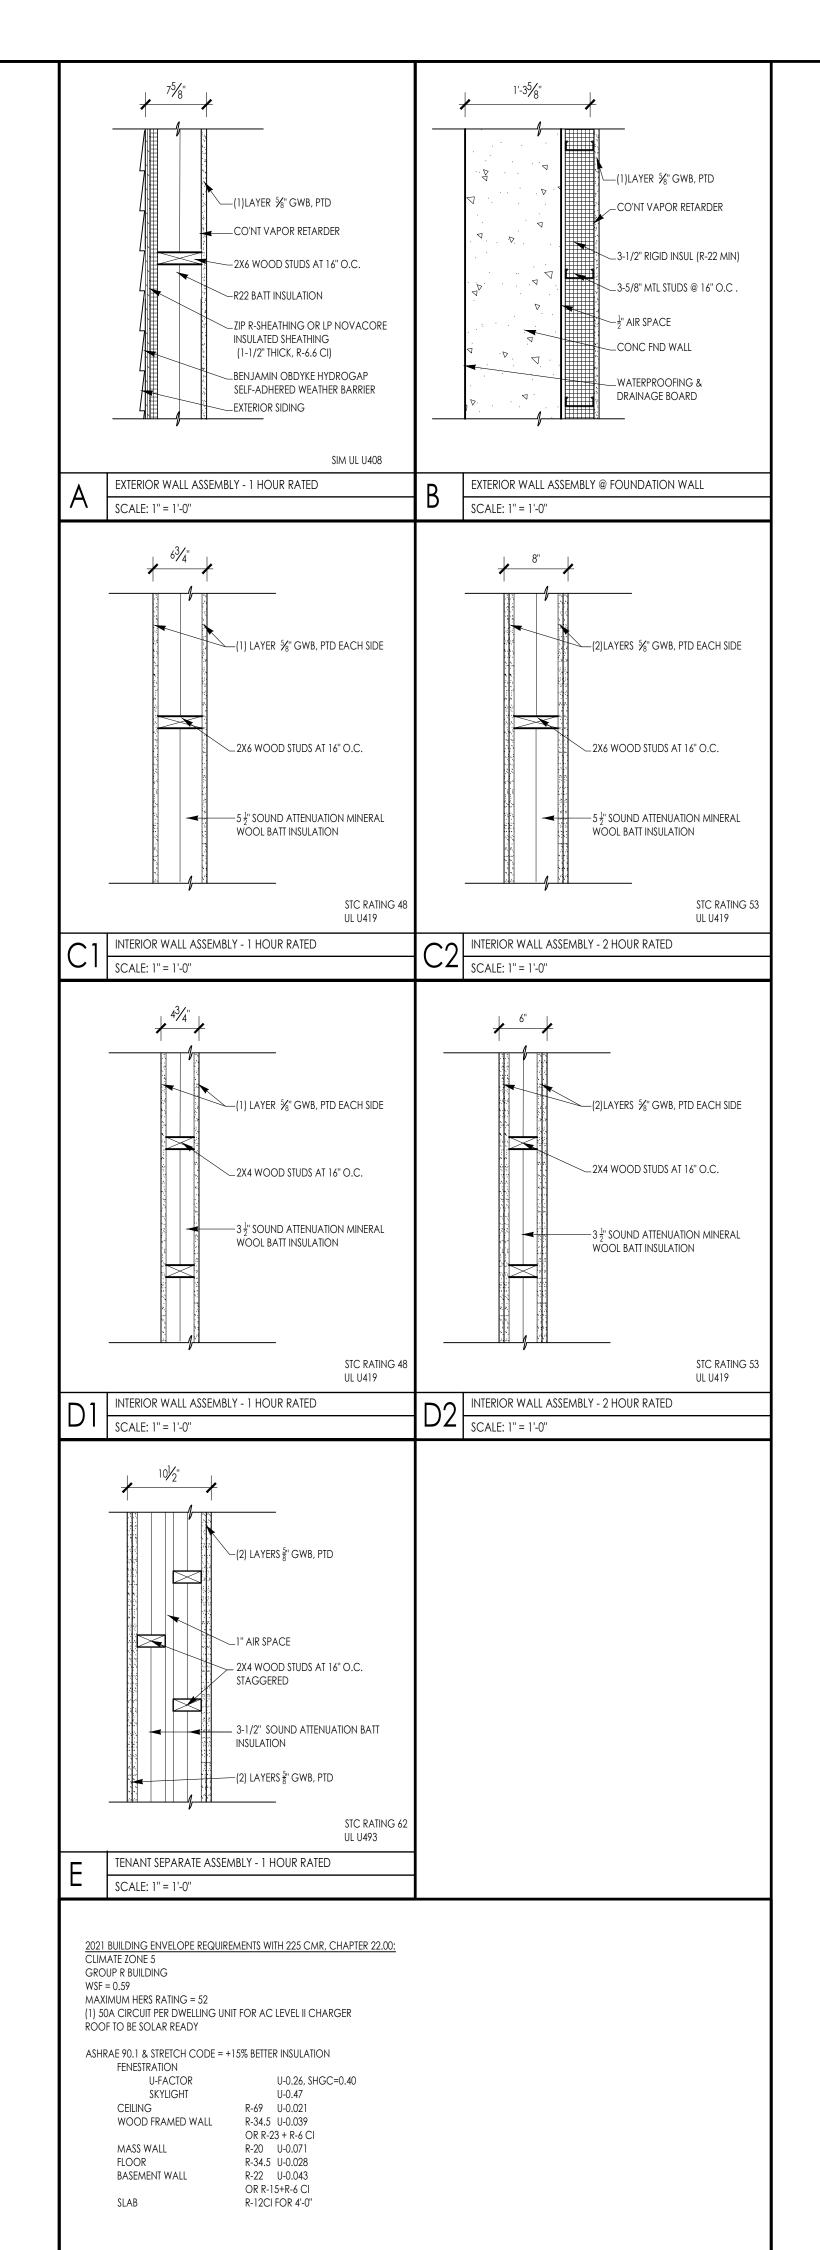


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DESIGN DEVELOPMENT 10.25.2023 BID N/A PERMIT 07.09.2024 CONSTRUCTION	3
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DESIGN DEVELOPMENT 10.25.2023 BID N/A PERMIT 07.09.2024 CONSTRUCTION EXISTING CONDITIONS	3
DESIGN DEVELOPMENT 10.25.2023 BID N/A PERMIT 07.09.2024 CONSTRUCTION EXISTING CONDITIONS 4	3
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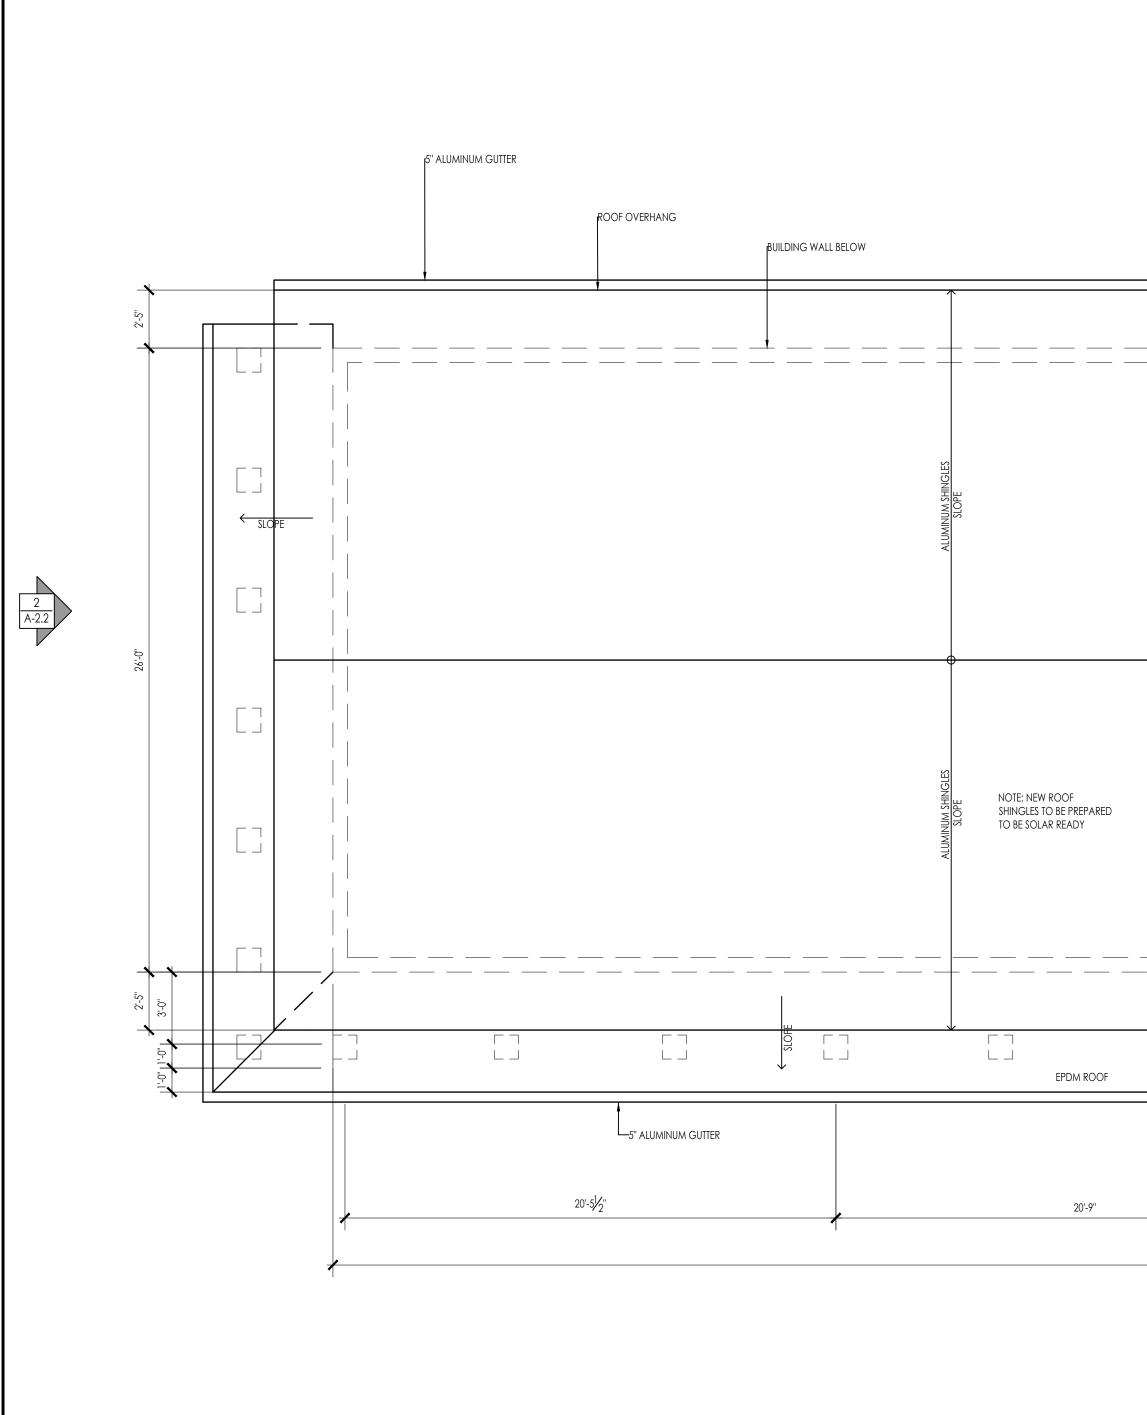


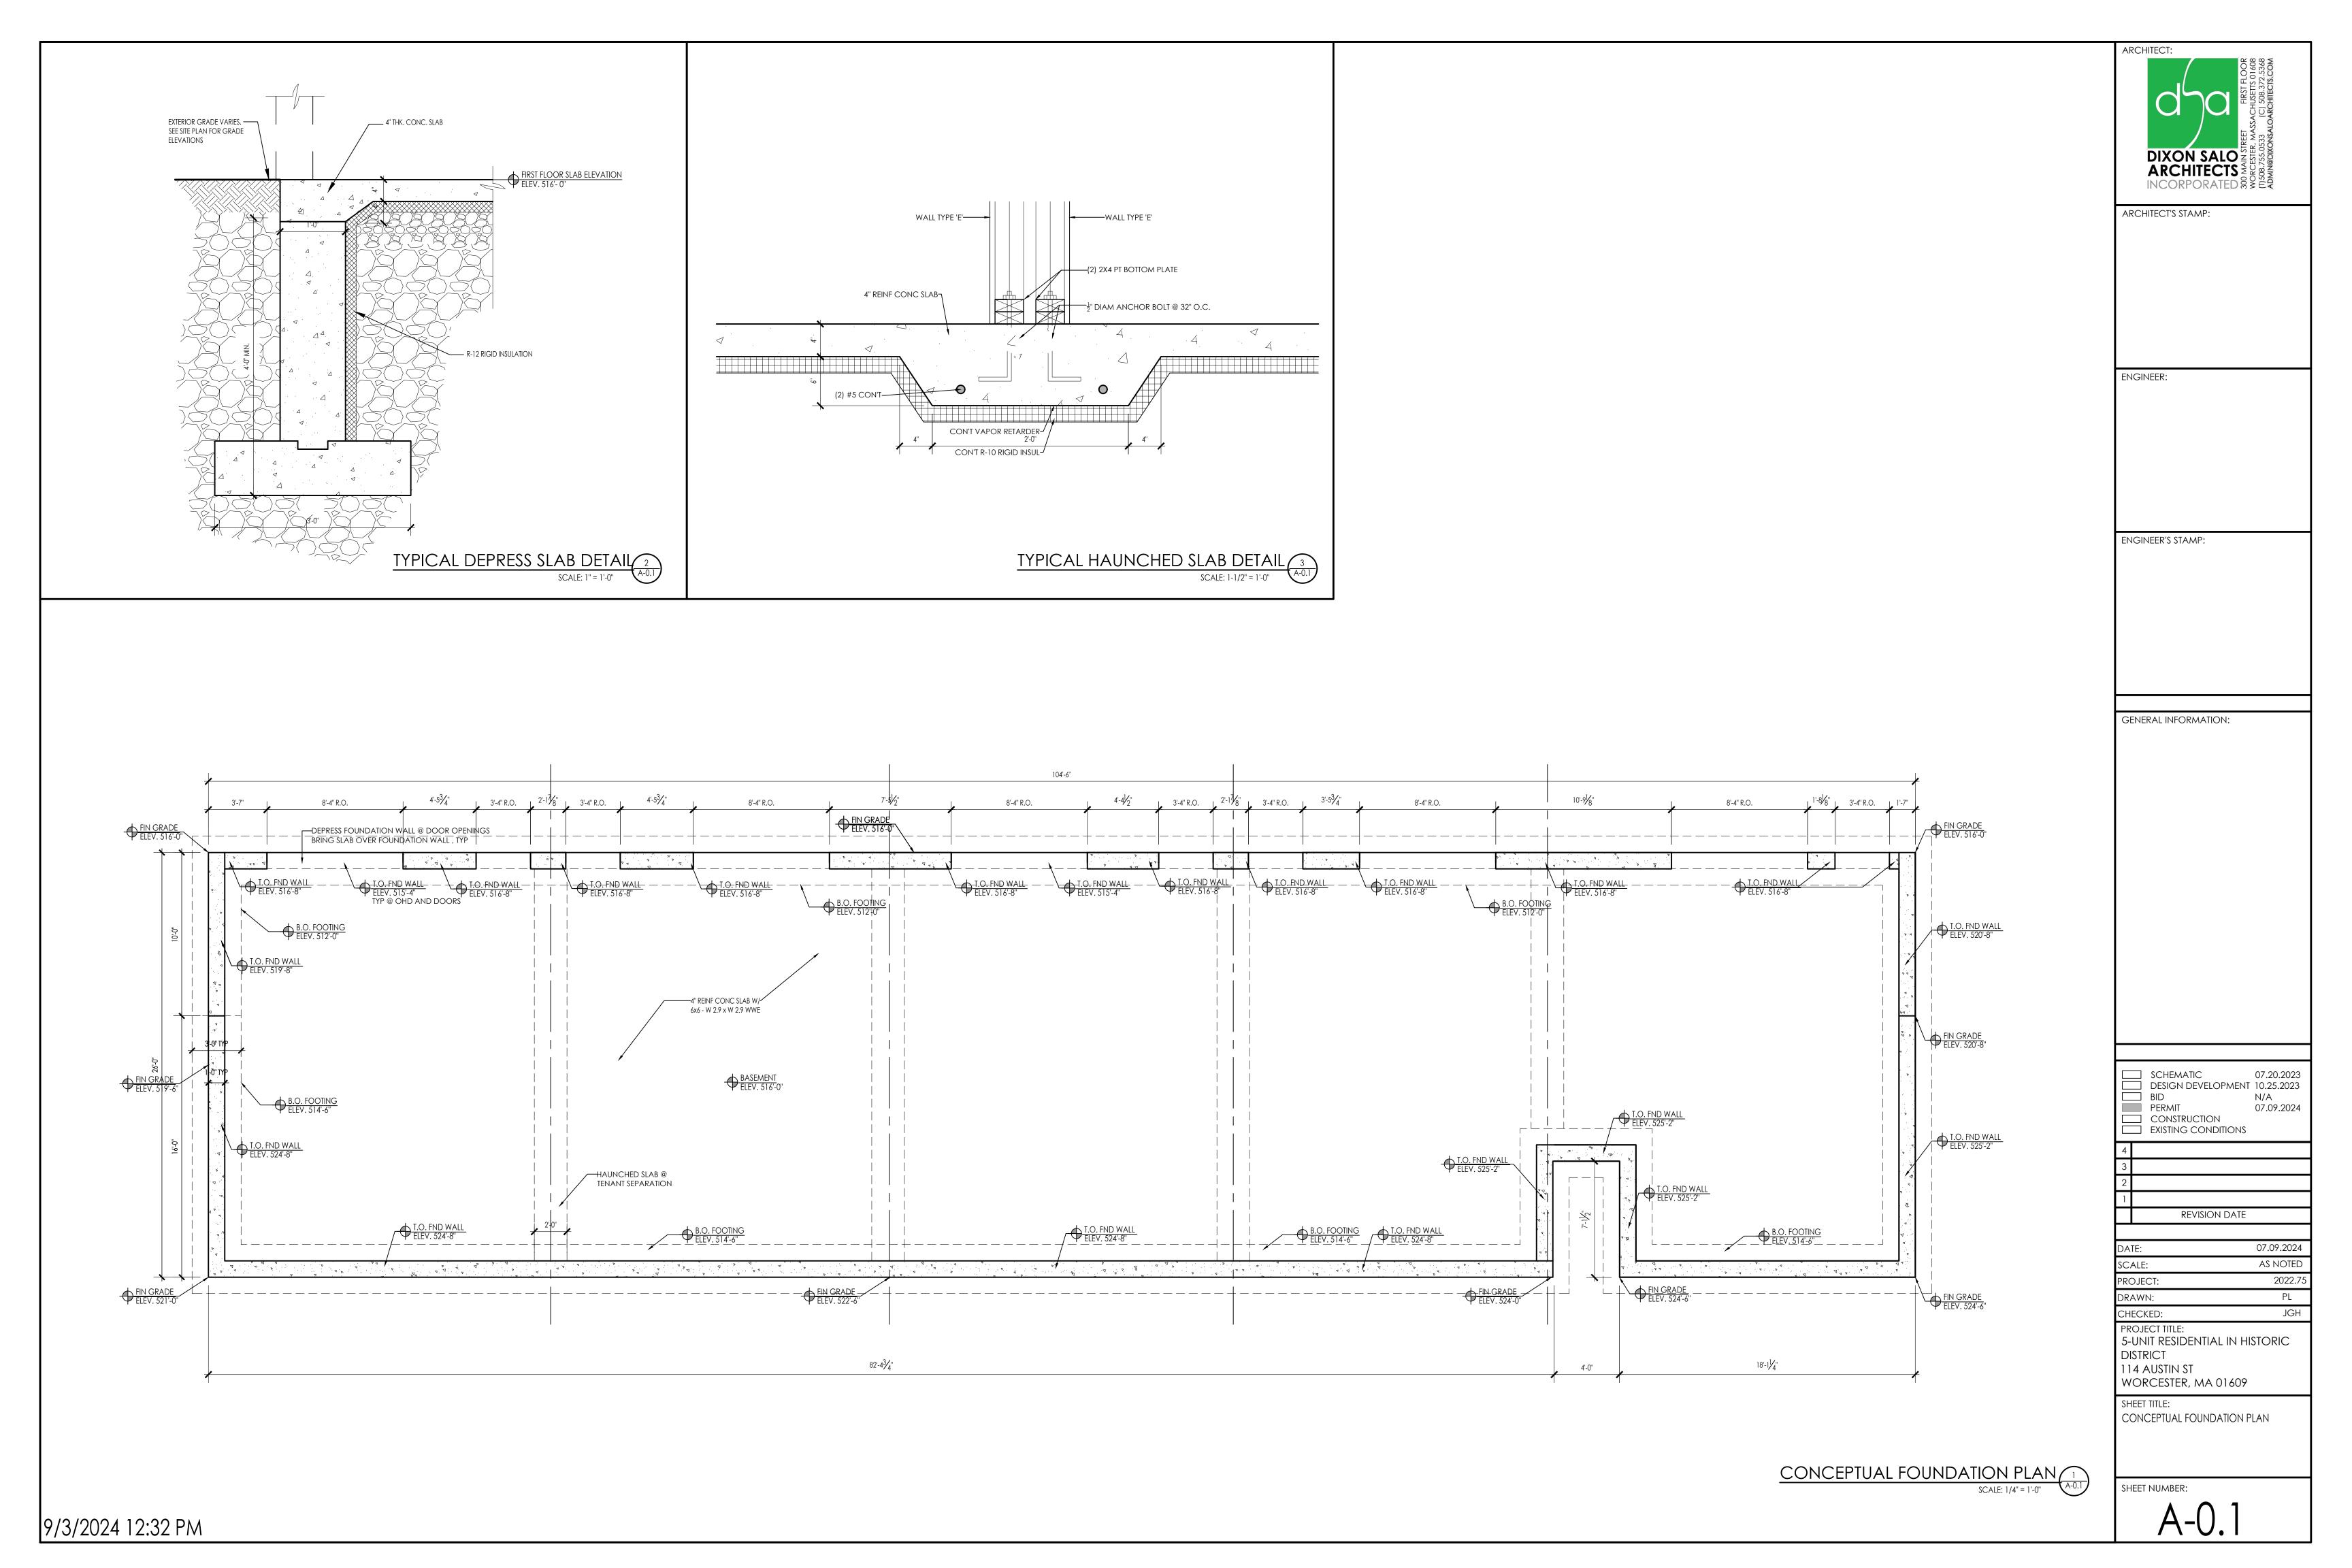

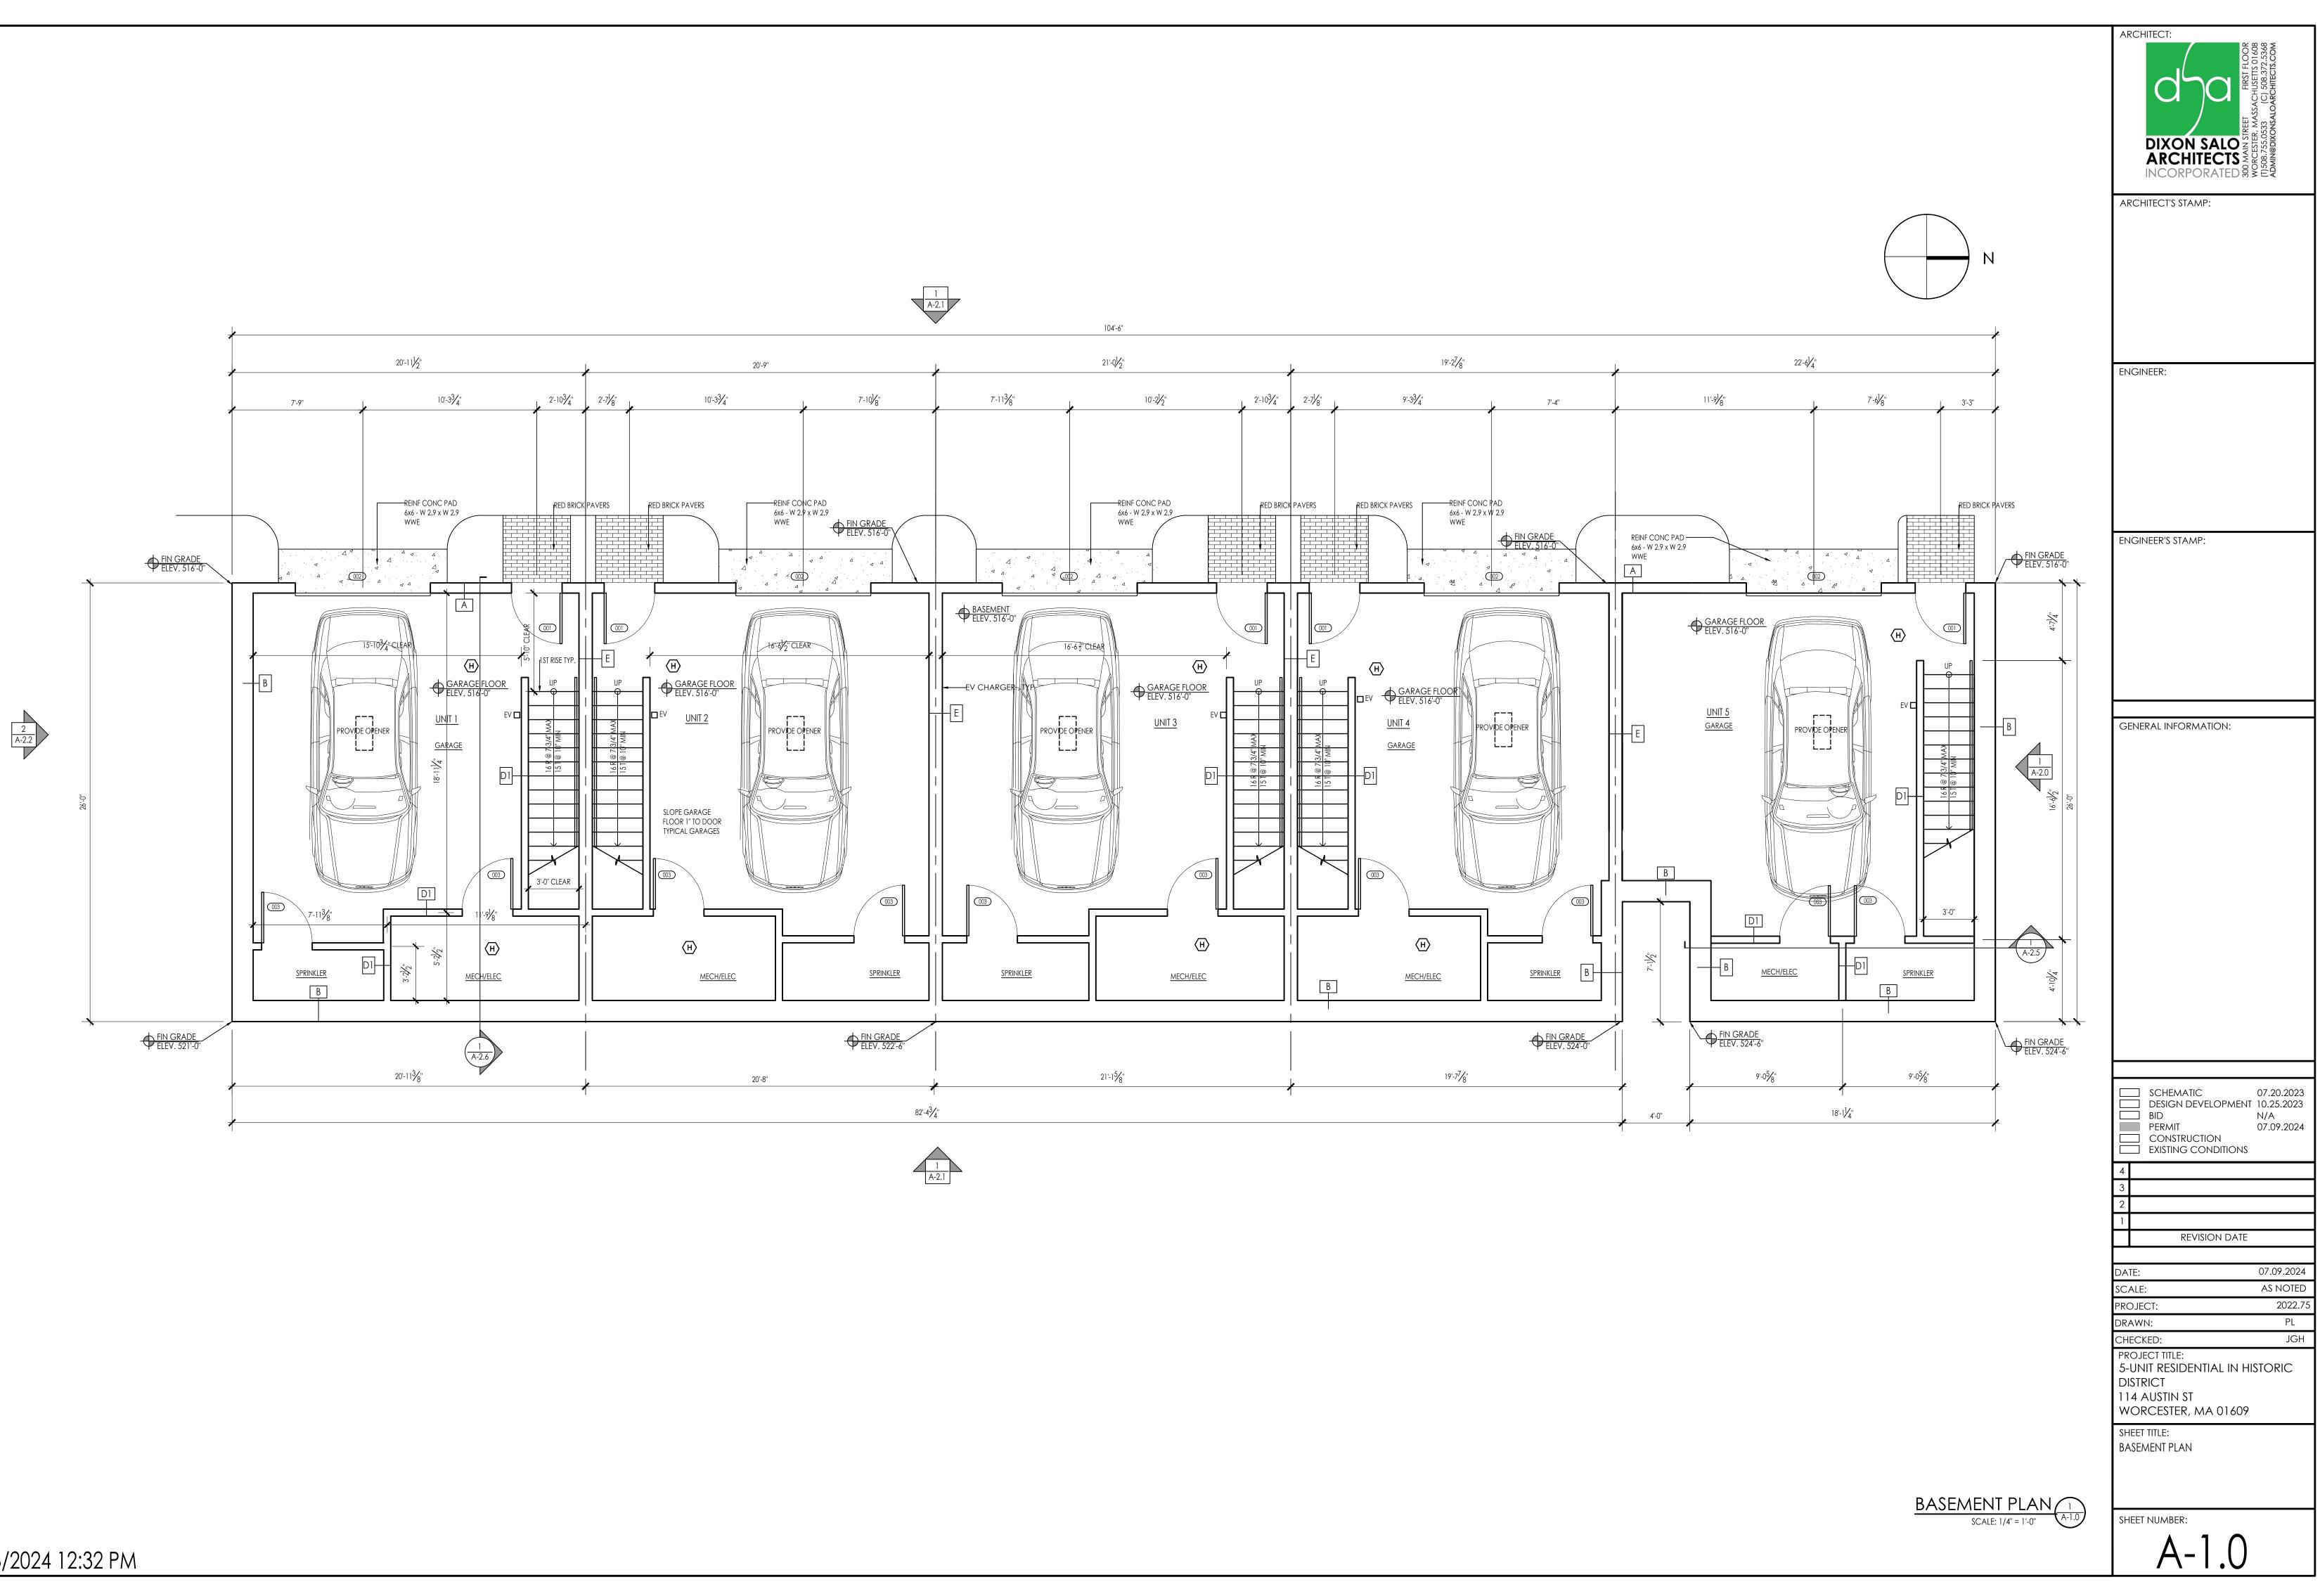

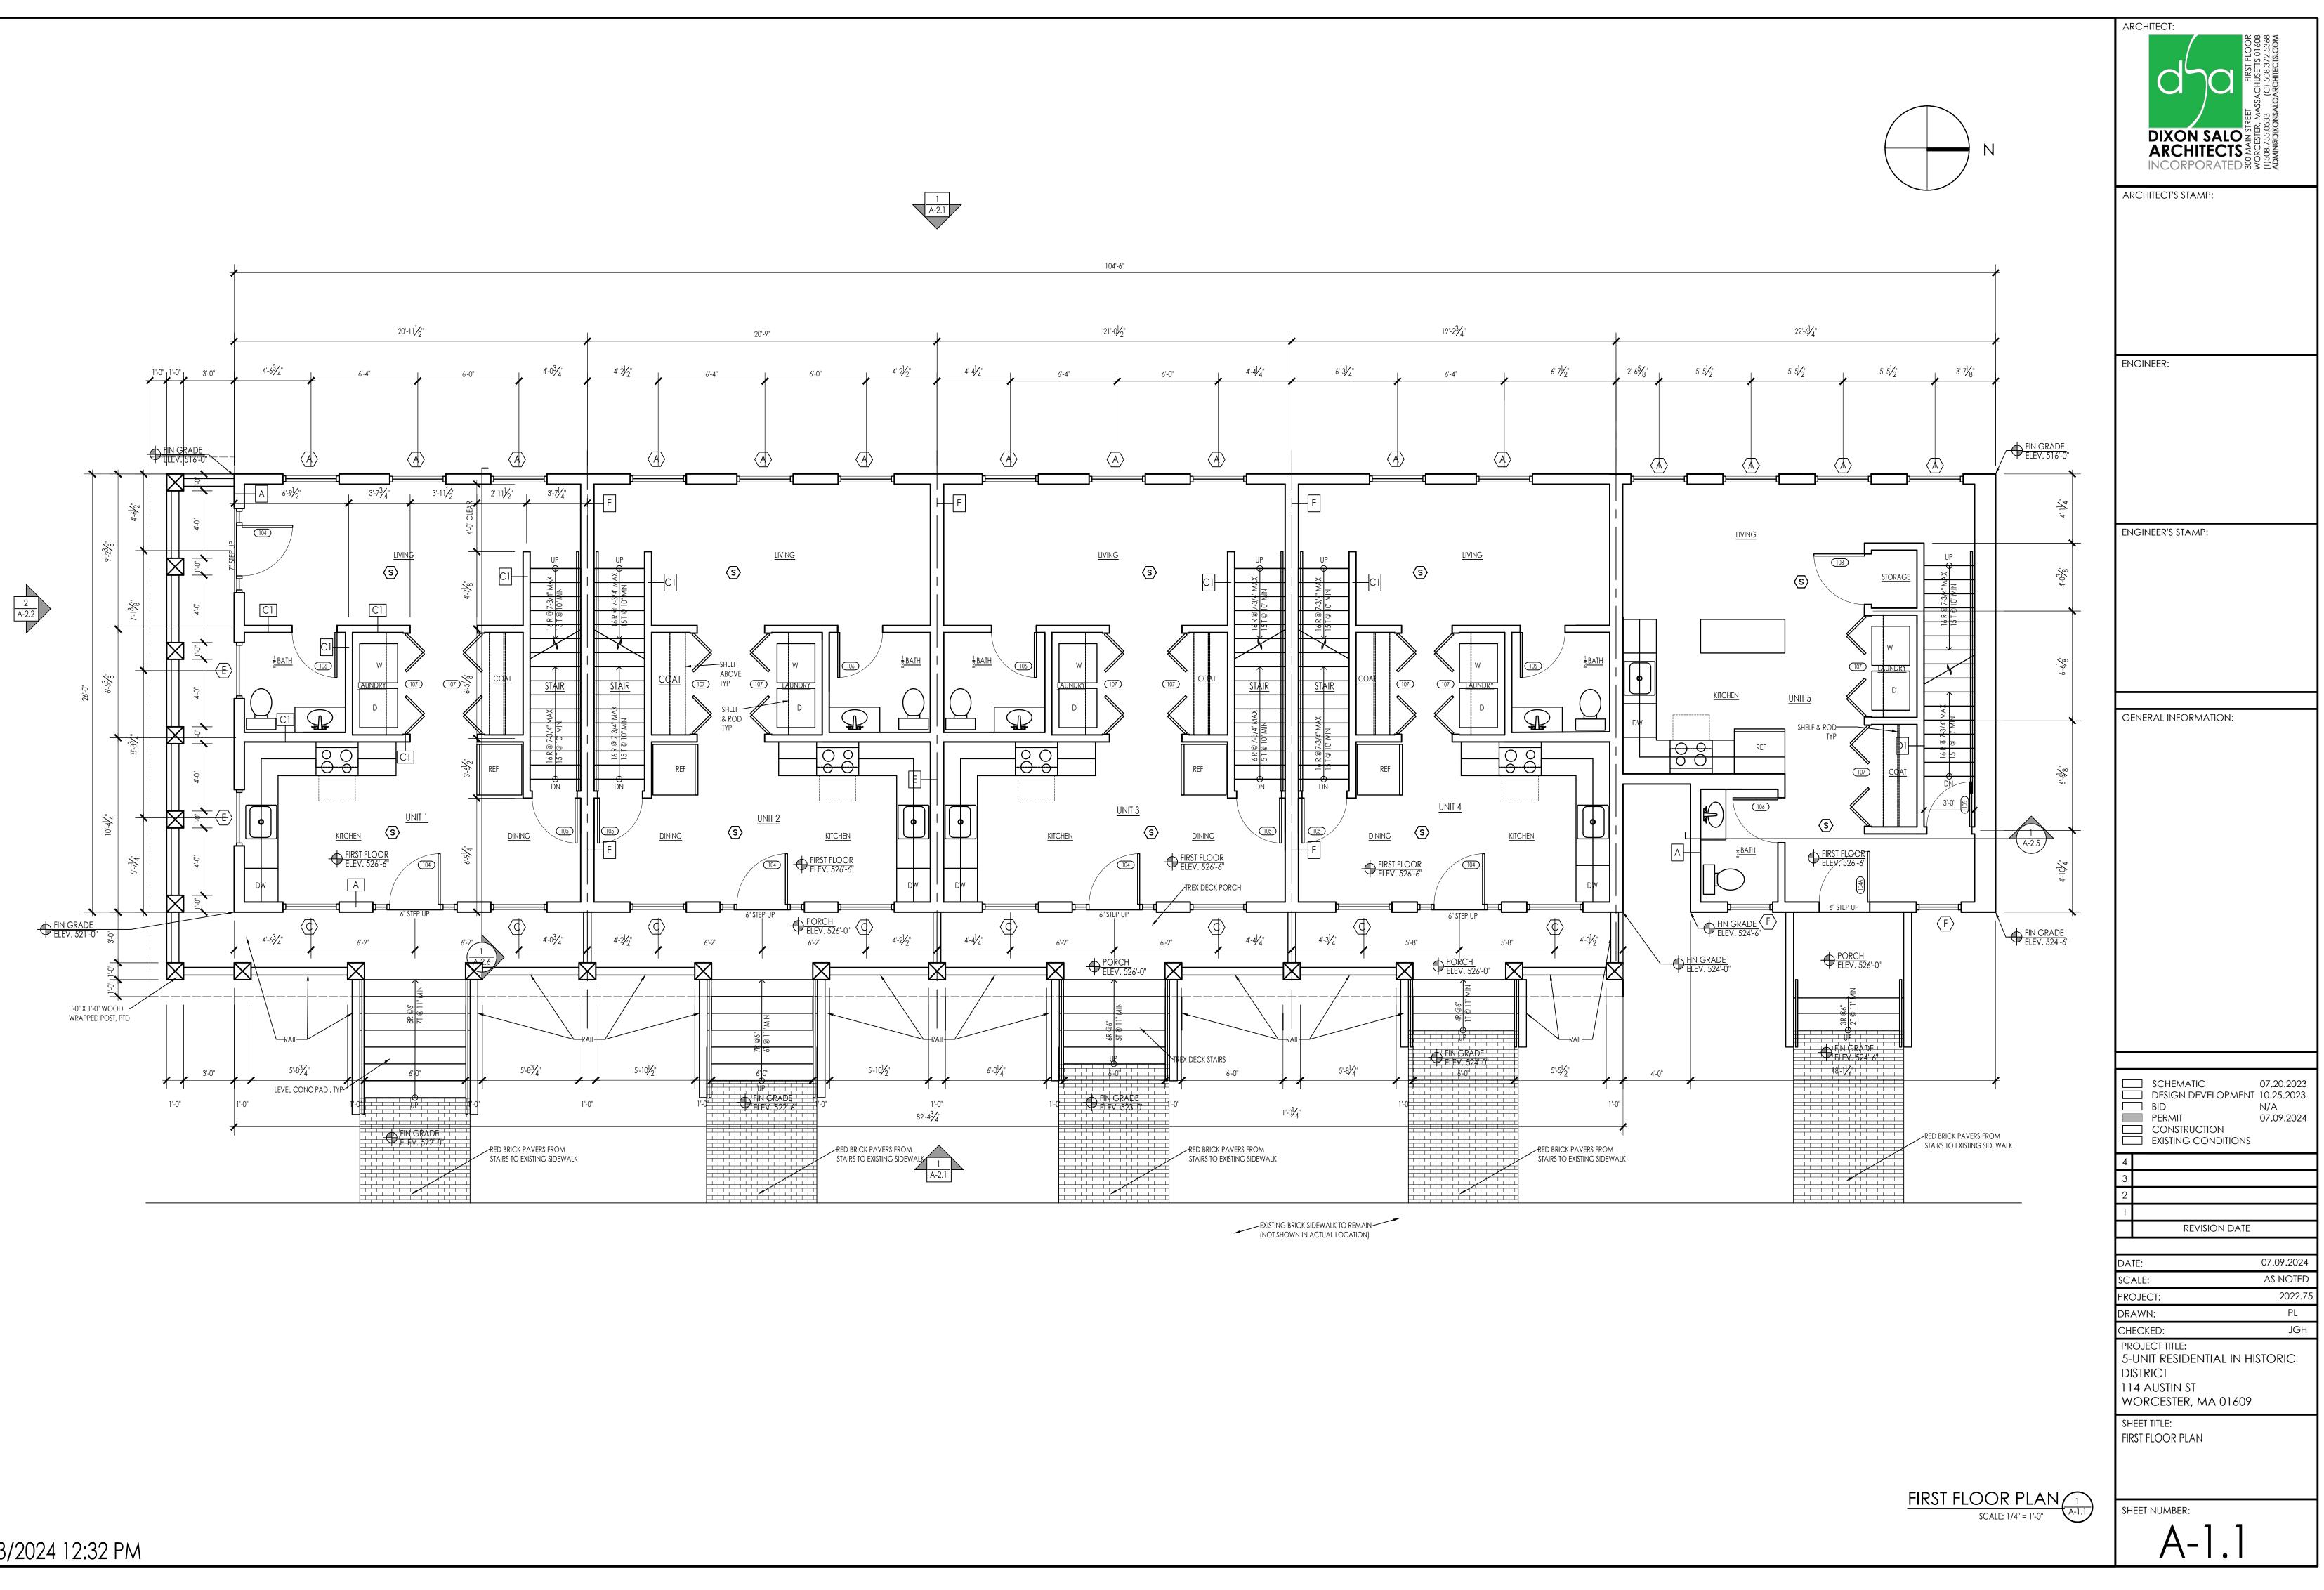

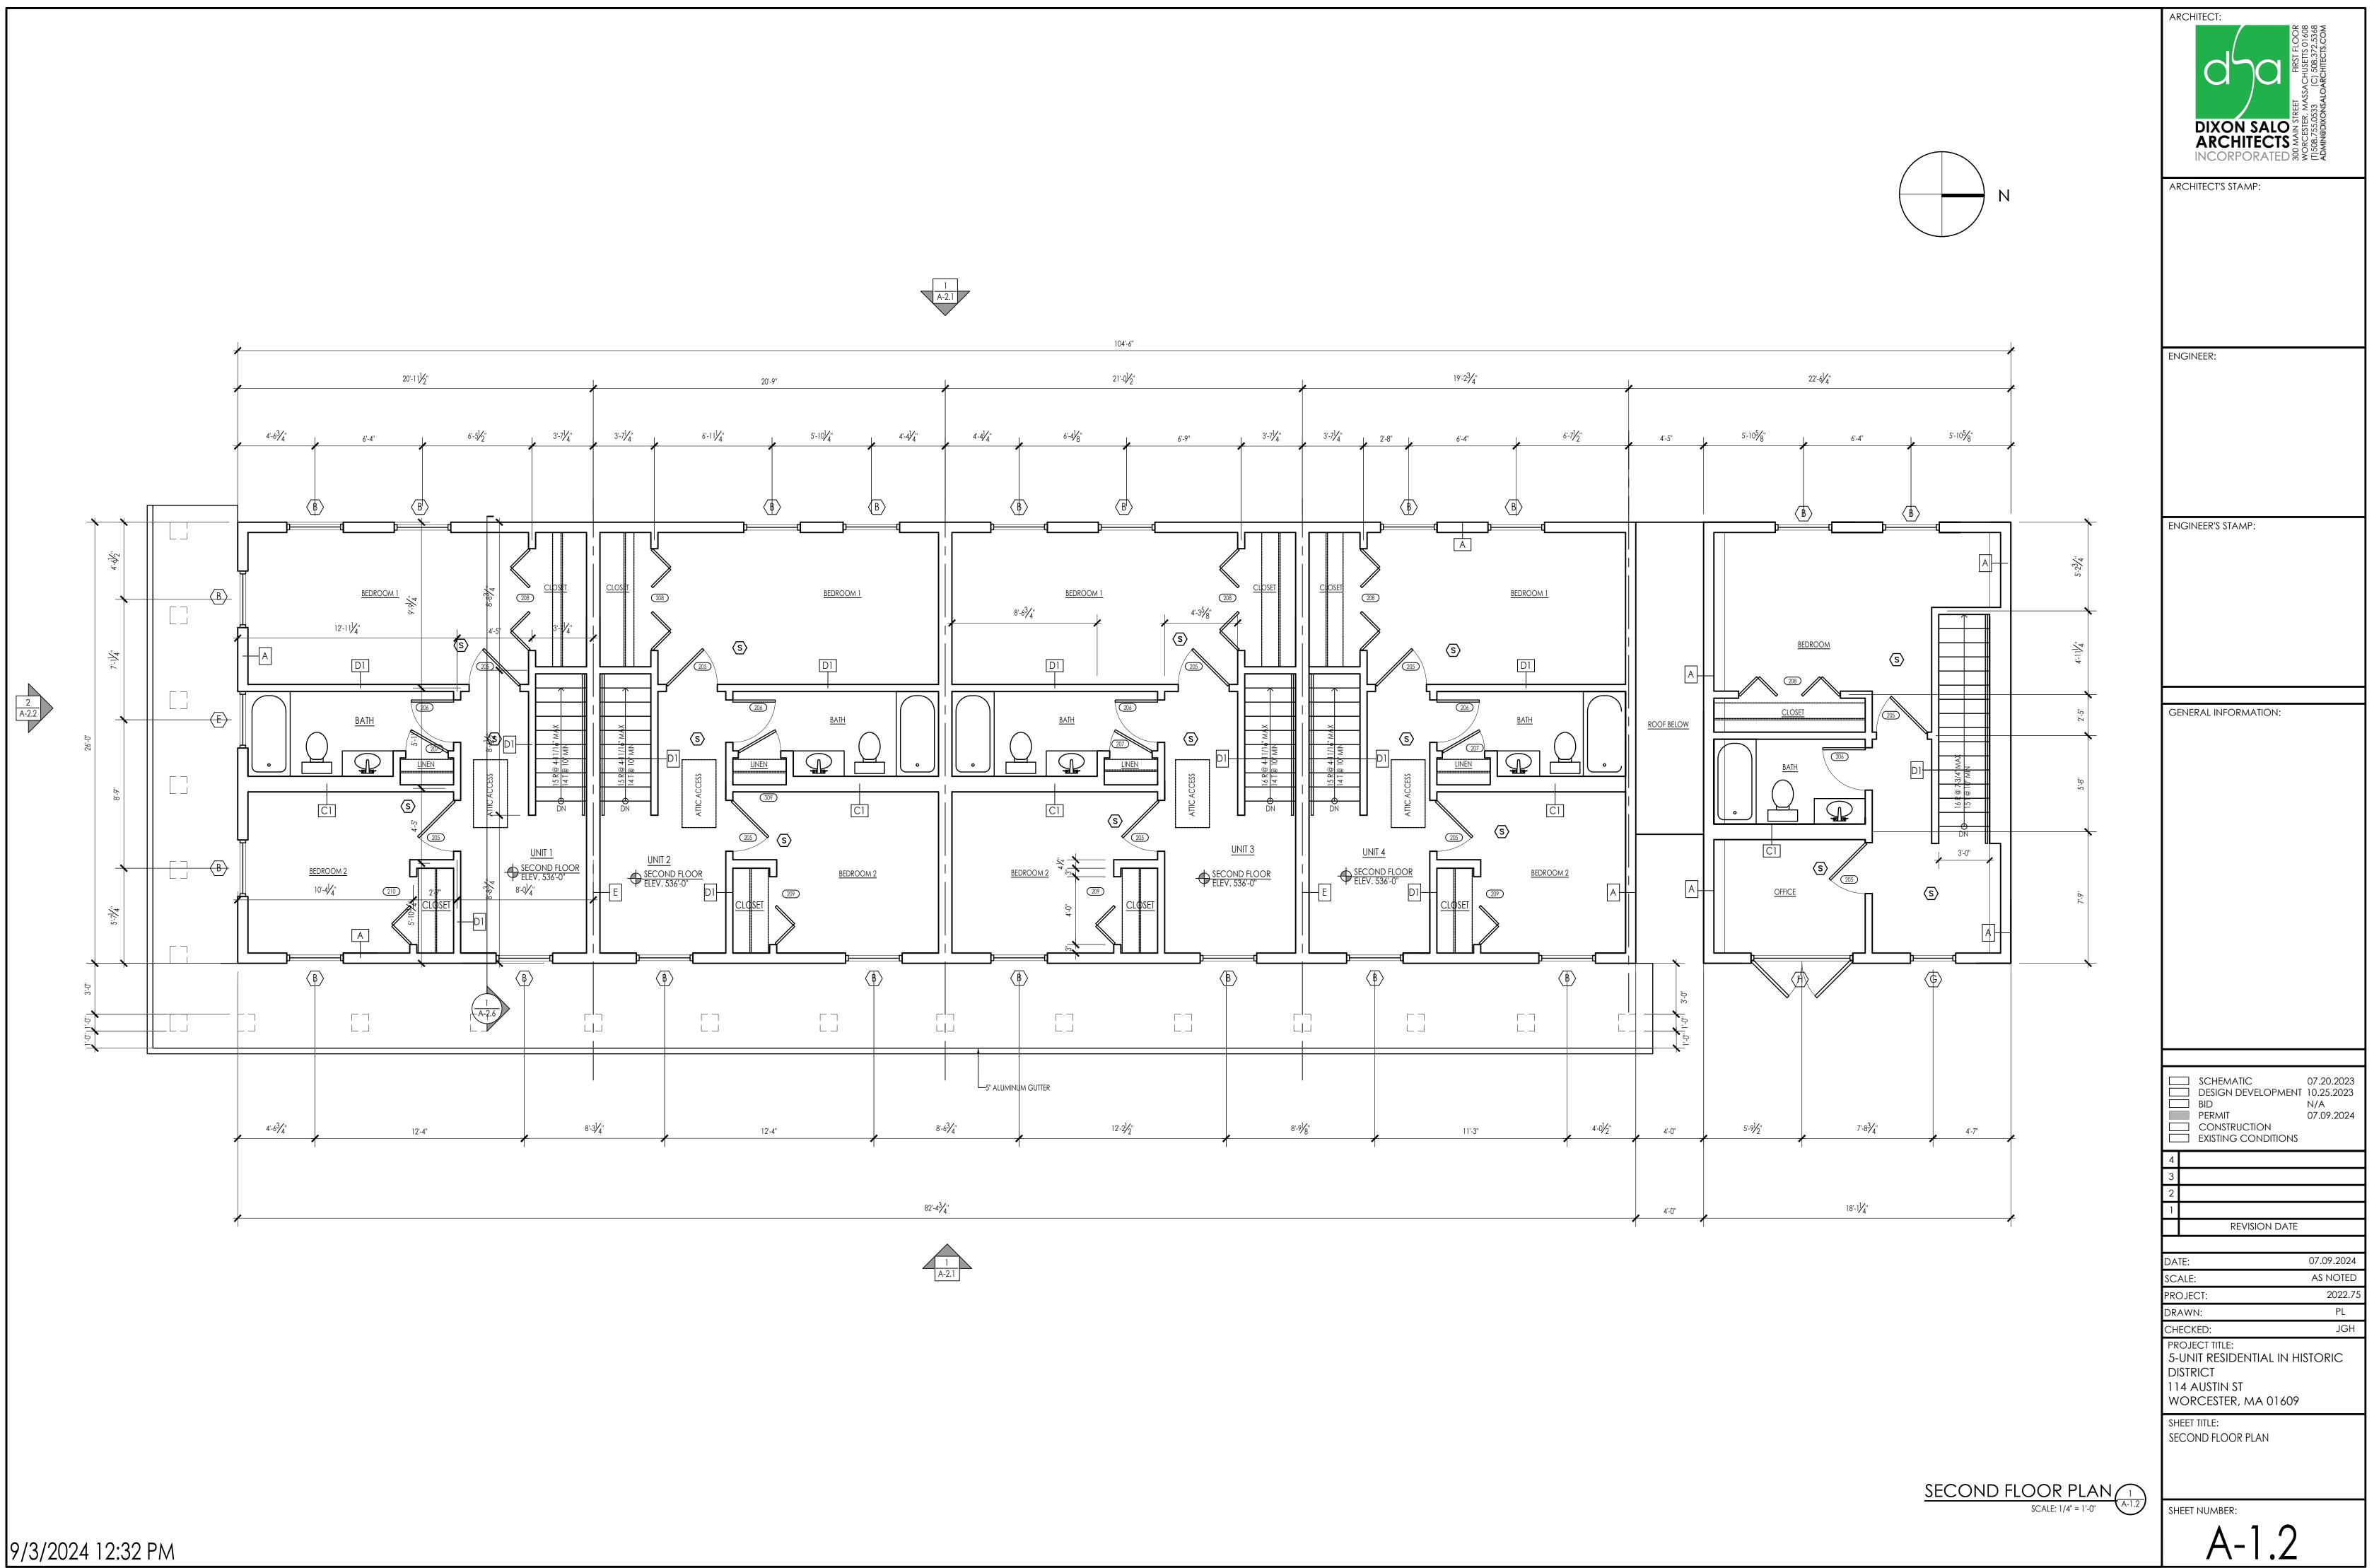








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	RIDGE VENT				
82'	1-4 ³ /4"	21'-0 ⁵ /8"		19'-17/8"	 e e



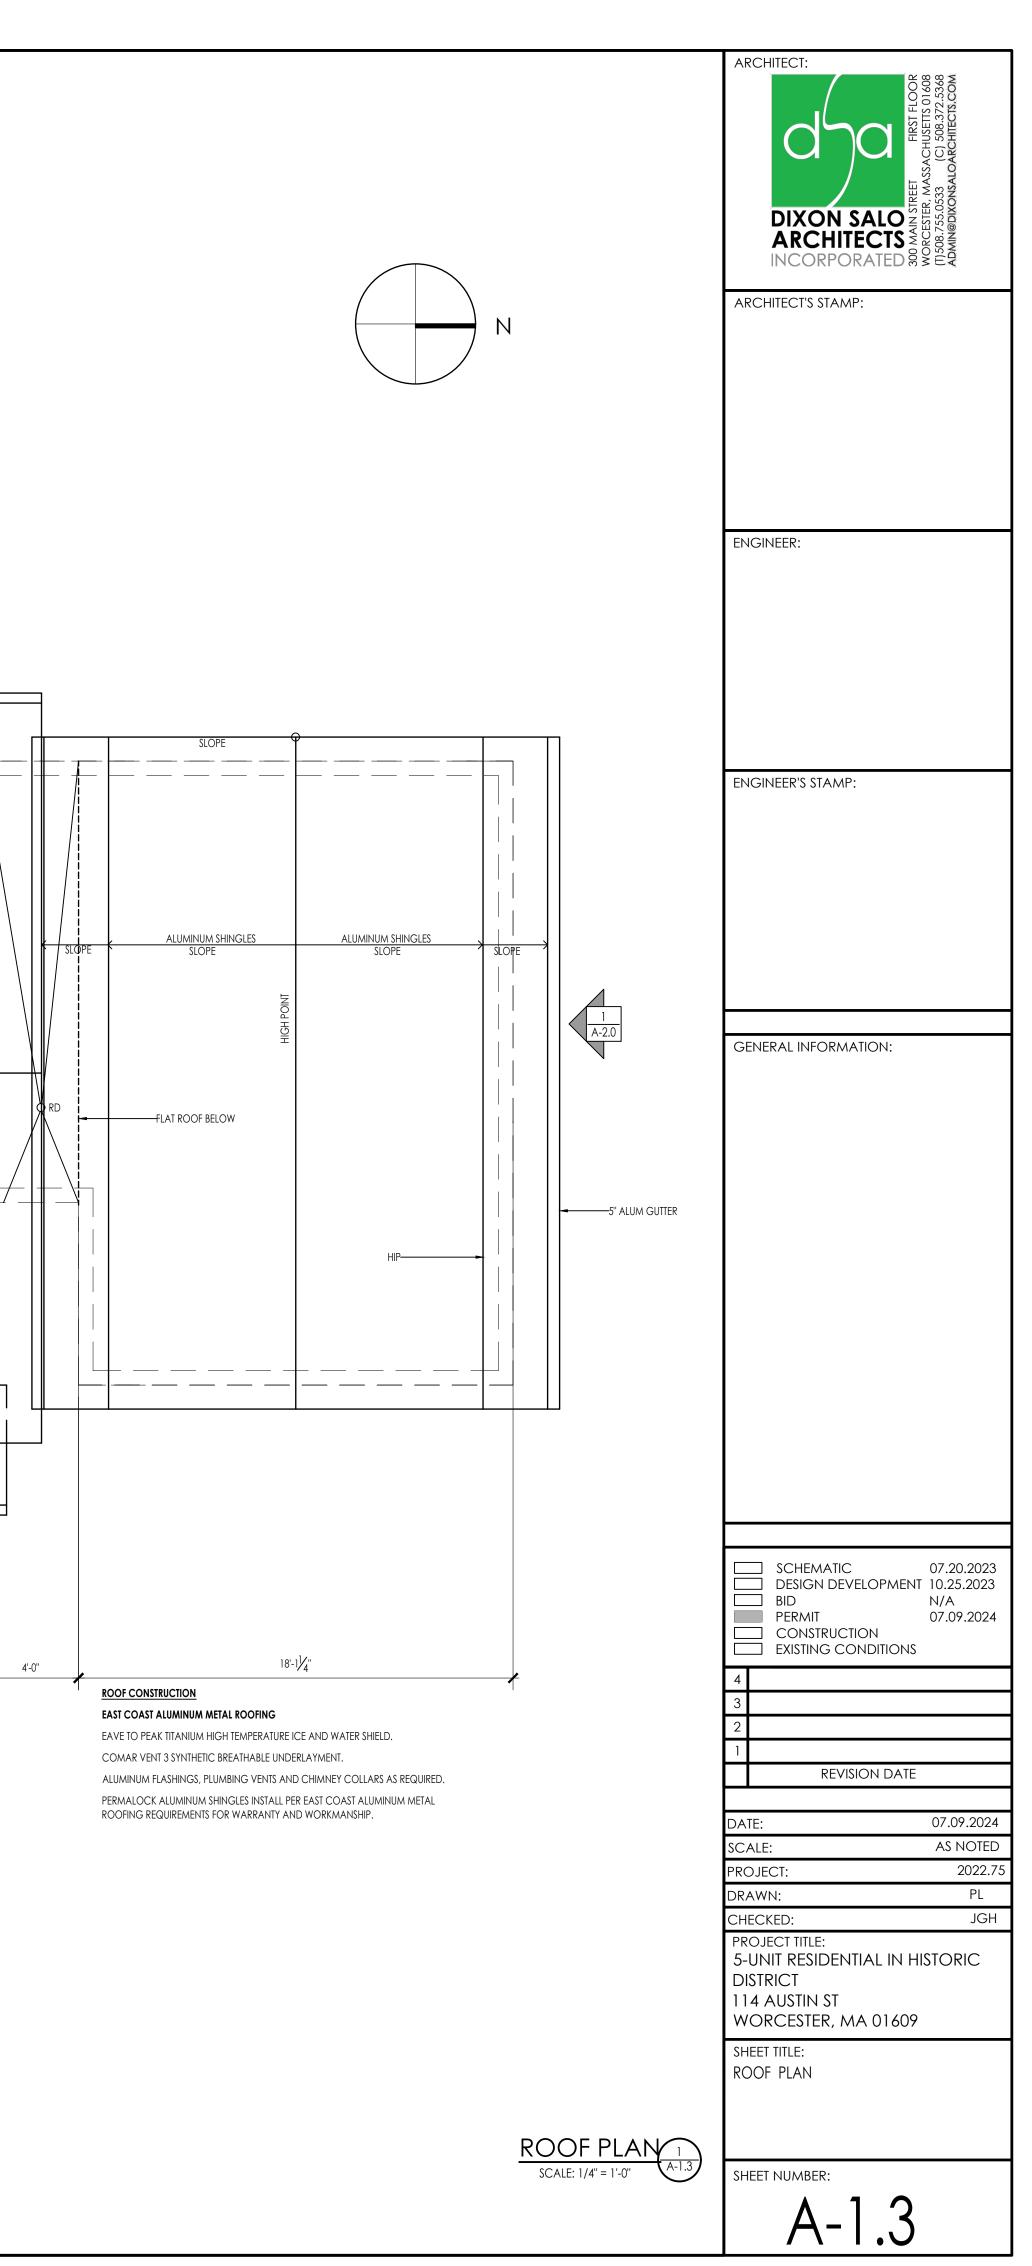

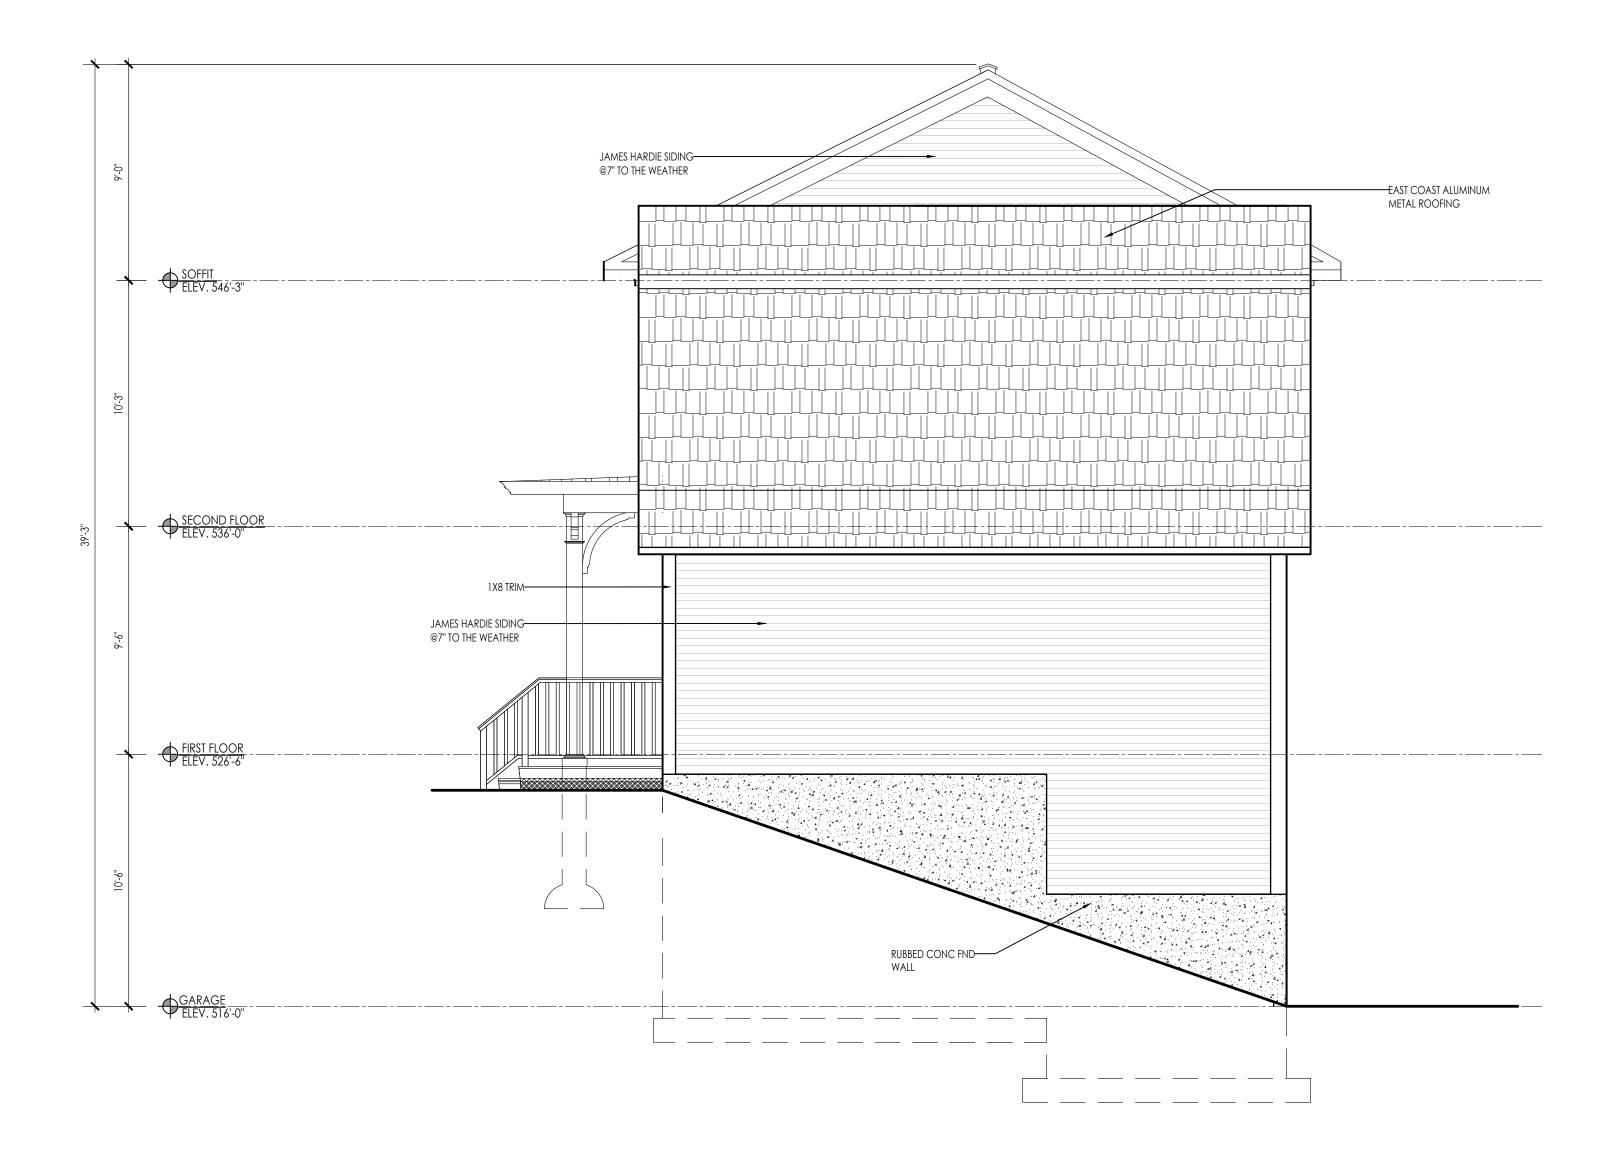


	ARCHITECT:
LIST OF MATERIALS ROOFING MATERIALS:	LOOF 01605 2.5368
SHINGLE - EAST COAST METAL ROOFING ALUMINUM ROOF SHINGLE - CHARCOAL GRAY	ARCHITECT: DIXON SALO MORCESTER, MASSACHURETTS 01608 1)508.755.0533 (C) 508.372.5368 MORCENTREL FIRST FLOOR MORCESTER, MASSACHURETTS 01608 1)508.755.0533 (C) 508.372.5368
SIDING MATERIALS: CLAPBOARD SIDING - FIBER CEMENT LAP SIDING SIMILAR TO JAMES HARDIE STATEMENT COLLECTION	ACH ACH ACH
PLANK LAP SIDING (7" EXPOSURE), COLOR - ARCTIC WHITE	A ASSA
GUARDS & HANDRAILS: HANDRAILS - VERANDA 36 IN. TRADITIONAL WHITE POLY-COMPOSITE RAIL GATE KIT W/ METAL BALUSTERS	
FENESTRATION: WINDOWS - MARVIN SIGNATURE SERIES, ULTIMATE WOOD, PAINTED WHITE	
DOORS - ANDERSEN WOOD ENTRY DOOR - PAINTED WHITE GARAGE DOOR - OVERHEAD DOOR COMPANY MODEL 303 ARCHED - 8'X7', GRAY/WHITE, 12 WINDOW ARCHED, CLEAR,	INCORPORATED S S E
BARCELONA HINGE, BARCELONA PULL SHUTTER - MILLWORK TRADERS STANDARD DUTY FIXED LOUVER 15"X48" - SPANISH CEDAR, PAINT GRADE, FACTORY PRIMED	
WHITE, PAINTED BLACK	ARCHITECT'S STAMP:
Corner molding - James Hardie Hardietrim $\frac{5}{4}, \frac{4}{4}$ trim - Smooth, Painted White Decking - trex transcend lineage - Jasper	
FENCING - VERANDA 36 IN. TRADITIONAL WHITE POLY-COMPOSITE RAIL GATE KIT W/ METAL BALUSTERS FRAMEWORK - 4x8 VERANDA WHITE GARDEN VINYL LATTICE	
COLUMN - BROSCO DSI ALUMINUM COLUMN - RECESSED BRACKET - BROSCO PVC OUTDOOR PRODUCTS BRACKETS - HBKT-2	
MOLDING - BROSCO INTEX MILLED & PRIMED PVC MOULDING - 7901	
EXTERIOR LIGHTING FIXTURES: HINKLEY FORGE 16-1/2" HIGH BLACK OUTDOOR BARN WALL LIGHT	
HINKLEY FORGE 12" HIGH BLACK OUTDOOR WALL LIGHT	
RETAINING WALL: STONE STRONG 6-28SF CHISELED GRANITE TEXTURE BLOCKS W/CAP	
	ENGINEER:
	ENGINEER'S STAMP:
	GENERAL INFORMATION:
	SCHEMATIC 07.20.2023
	DESIGN DEVELOPMENT 10.25.2023
	DESIGN DEVELOPMENT 10.25.2023 BID N/A PERMIT 07.09.2024
	DESIGN DEVELOPMENT 10.25.2023 BID N/A PERMIT 07.09.2024 CONSTRUCTION
	DESIGN DEVELOPMENT 10.25.2023 BID N/A PERMIT 07.09.2024
	DESIGN DEVELOPMENT 10.25.2023 BID N/A PERMIT 07.09.2024 CONSTRUCTION EXISTING CONDITIONS
	DESIGN DEVELOPMENT 10.25.2023 BID N/A PERMIT 07.09.2024 CONSTRUCTION EXISTING CONDITIONS 4 3
	DESIGN DEVELOPMENT 10.25.2023 BID N/A PERMIT 07.09.2024 CONSTRUCTION EXISTING CONDITIONS
	DESIGN DEVELOPMENT 10.25.2023 BID N/A PERMIT 07.09.2024 CONSTRUCTION EXISTING CONDITIONS 4 3 2 1
	DESIGN DEVELOPMENT 10.25.2023 BID N/A PERMIT 07.09.2024 CONSTRUCTION EXISTING CONDITIONS 4 3
	DESIGN DEVELOPMENT 10.25.2023 BID N/A PERMIT 07.09.2024 CONSTRUCTION EXISTING CONDITIONS 4 3 2 1 REVISION DATE
	DESIGN DEVELOPMENT 10.25.2023 BID N/A PERMIT 07.09.2024 CONSTRUCTION EXISTING CONDITIONS 4 3 2 1 REVISION DATE
	DESIGN DEVELOPMENT 10.25.2023 BID N/A PERMIT 07.09.2024 CONSTRUCTION EXISTING CONDITIONS 4 3 2 1 REVISION DATE DATE: 07.09.2024 SCALE: AS NOTED
	DESIGN DEVELOPMENT 10.25.2023 BID N/A PERMIT 07.09.2024 CONSTRUCTION EXISTING CONDITIONS 4 3 2 1 REVISION DATE DATE: 07.09.2024 SCALE: AS NOTED PROJECT: 2022.75
	DESIGN DEVELOPMENT 10.25.2023 BID N/A PERMIT 07.09.2024 CONSTRUCTION EXISTING CONDITIONS 4 3 2 1 REVISION DATE DATE: 07.09.2024 SCALE: AS NOTED PROJECT: 2022.75 DRAWN: PL
	DESIGN DEVELOPMENT 10.25.2023 BID N/A PERMIT 07.09.2024 CONSTRUCTION EXISTING CONDITIONS 4 3 2 1 REVISION DATE DATE: 07.09.2024 SCALE: AS NOTED PROJECT: 2022.75 DRAWN: PL CHECKED: JGH
	DESIGN DEVELOPMENT 10.25.2023 BID N/A PERMIT 07.09.2024 CONSTRUCTION EXISTING CONDITIONS 4 3 2 1 REVISION DATE DATE: 07.09.2024 SCALE: AS NOTED PROJECT: 2022.75 DRAWN: PL
	DESIGN DEVELOPMENT 10.25.2023 BID N/A PERMIT 07.09.2024 CONSTRUCTION EXISTING CONDITIONS 4 3 2 1 REVISION DATE DATE: 07.09.2024 SCALE: AS NOTED PROJECT: 2022.75 DRAWN: PL CHECKED: JGH PROJECT TITLE: 5-UNIT RESIDENTIAL IN HISTORIC DISTRICT
	DESIGN DEVELOPMENT 10.25.2023 BID N/A PERMIT 07.09.2024 CONSTRUCTION EXISTING CONDITIONS 4 3 2 1 DATE: 07.09.2024 SCALE: AS NOTED PROJECT: 2022.75 DRAWN: PL CHECKED: JGH PROJECT TITLE: 5-UNIT RESIDENTIAL IN HISTORIC DISTRICT 114 AUSTIN ST
	DESIGN DEVELOPMENT 10.25.2023 BID N/A PERMIT 07.09.2024 CONSTRUCTION EXISTING CONDITIONS 4 3 2 1 REVISION DATE DATE: 07.09.2024 SCALE: AS NOTED PROJECT: 2022.75 DRAWN: PL CHECKED: JGH PROJECT TITLE: 5-UNIT RESIDENTIAL IN HISTORIC DISTRICT
	DESIGN DEVELOPMENT 10.25.2023 BID N/A PERMIT 07.09.2024 CONSTRUCTION EXISTING CONDITIONS 4 3 2 1 REVISION DATE DATE: 07.09.2024 SCALE: AS NOTED PROJECT: 2022.75 DRAWN: PL CHECKED: JGH PROJECT TITLE: 5-UNIT RESIDENTIAL IN HISTORIC DISTRICT 114 AUSTIN ST WORCESTER, MA 01609 SHEET TITLE:
	DESIGN DEVELOPMENT 10.25.2023 BID N/A PERMIT 07.09.2024 CONSTRUCTION EXISTING CONDITIONS 4 3 2 1 REVISION DATE DATE: 07.09.2024 SCALE: AS NOTED PROJECT: 2022.75 DRAWN: PL CHECKED: JGH PROJECT TITLE: 5-UNIT RESIDENTIAL IN HISTORIC DISTRICT 114 AUSTIN ST WORCESTER, MA 01609
	DESIGN DEVELOPMENT 10.25.2023 BID N/A PERMIT 07.09.2024 CONSTRUCTION EXISTING CONDITIONS 4 3 2 1 REVISION DATE DATE: 07.09.2024 SCALE: AS NOTED PROJECT: 2022.75 DRAWN: PL CHECKED: JGH PROJECT TITLE: 5-UNIT RESIDENTIAL IN HISTORIC DISTRICT 114 AUSTIN ST WORCESTER, MA 01609 SHEET TITLE:
	DESIGN DEVELOPMENT 10.25.2023 BID N/A PERMIT 07.09.2024 CONSTRUCTION EXISTING CONDITIONS 4 3 2 1 REVISION DATE DATE: 07.09.2024 SCALE: AS NOTED PROJECT: 2022.75 DRAWN: PL CHECKED: JGH PROJECT TITLE: 5-UNIT RESIDENTIAL IN HISTORIC DISTRICT 114 AUSTIN ST WORCESTER, MA 01609 SHEET TITLE:
SIDE ELEVATION	DESIGN DEVELOPMENT 10.25.2023 BID N/A PERMIT 07.09.2024 CONSTRUCTION EXISTING CONDITIONS 4 3 2 1 REVISION DATE DATE: 07.09.2024 SCALE: AS NOTED PROJECT: 2022.75 DRAWN: PL CHECKED: JGH PROJECT TITLE: 5-UNIT RESIDENTIAL IN HISTORIC DISTRICT 114 AUSTIN ST WORCESTER, MA 01609 SHEET TITLE:
SDE ELEVATION	DESIGN DEVELOPMENT 10.25.2023 BID N/A PERMIT 07.09.2024 CONSTRUCTION EXISTING CONDITIONS 4 3 2 1 REVISION DATE DATE: 07.09.2024 SCALE: AS NOTED PROJECT: 2022.75 DRAWN: PL CHECKED: JGH PROJECT TITLE: 5-UNIT RESIDENTIAL IN HISTORIC DISTRICT 114 AUSTIN ST WORCESTER, MA 01609 SHEET TITLE:
	DESIGN DEVELOPMENT 10.25.2023 BID N/A PERMIT 07.09.2024 CONSTRUCTION EXISTING CONDITIONS 4 3 2 1 REVISION DATE DATE: 07.09.2024 SCALE: 07.09.2024 SCALE: AS NOTED PROJECT: 2022.75 DRAWN: PL CHECKED: JGH PROJECT TITLE: 5-UNIT RESIDENTIAL IN HISTORIC DISTRICT 114 AUSTIN ST WORCESTER, MA 01609 SHEET TITLE: SIDE ELEVATION SHEET NUMBER:
	DESIGN DEVELOPMENT 10.25.2023 BID N/A PERMIT 07.09.2024 CONSTRUCTION EXISTING CONDITIONS 4 3 2 1 REVISION DATE DATE: 07.09.2024 SCALE: AS NOTED PROJECT: 2022.75 DRAWN: PL CHECKED: JGH PROJECT TITLE: 5-UNIT RESIDENTIAL IN HISTORIC DISTRICT 114 AUSTIN ST WORCESTER, MA 01609 SHEET TITLE: SIDE ELEVATION

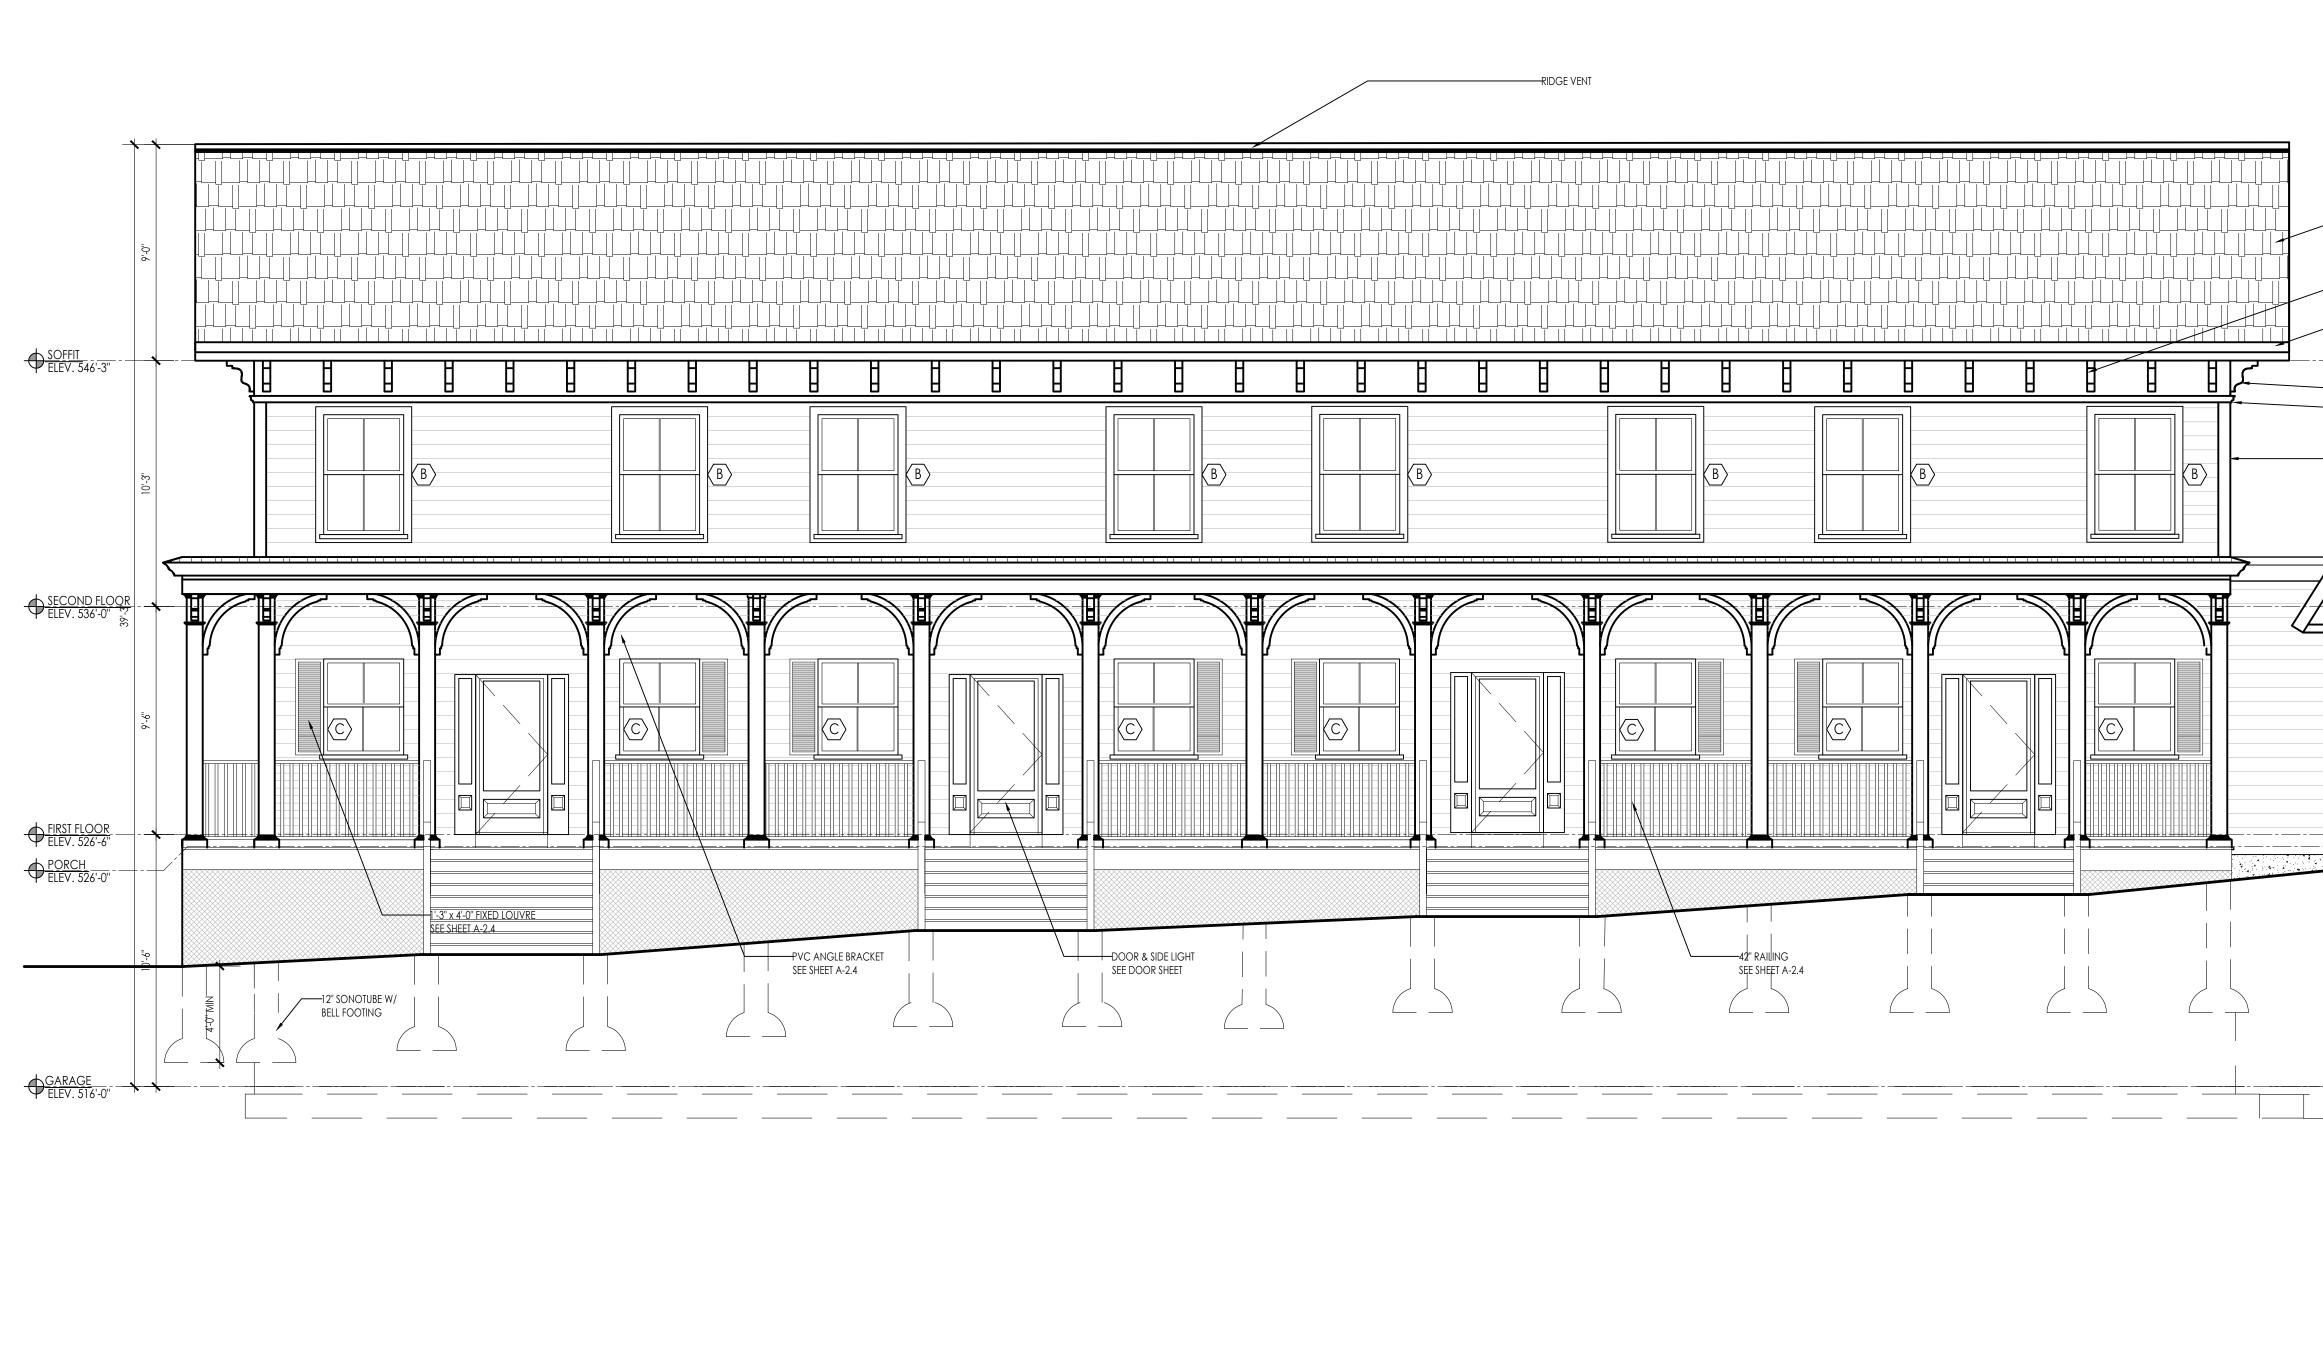



LIST OF MATERIALS ROOFING MATERIALS: SHINGLE - EAST COAST METAL ROOFING ALUMINUM ROOF SHINGLE - CHARCOAL GRAY SIDING MATERIALS: CLAPBOARD SIDING - FIBER CEMENT LAP SIDING SIMILAR TO JAMES HARDIE STATEMENT COLLECTION PLANK LAP SIDING (7" EXPOSURE), COLOR - ARCTIC WHITE GUARDS & HANDRAILS: HANDRAILS - VERANDA 36 IN. TRADITIONAL WHITE POLY-COMPOSITE RAIL GATE KIT W/ METAL BALLISTERS HENESTRATION: WINDOWS - MARVIN SIGNATURE SERIES, ULTIMATE WOOD, PAINTED WHITE DOORS - ANDERSEN WOOD ENTRY DOOR - PAINTED WHITE GOARAGE DOOR - OVERHEAD DOOR COMPANY MODEL 303 ARCHED - 8"X7", GRAY/WHITE, 12 WINDOW ARCHED, CLEAR, BARCELONA HINGE, BARCELONA PULL SHUTTER - MILLWORK TRADERS STANDARD DUTY FIXED LOUVER 15"X48" - SPANISH CEDAR, PAINT GRADE, FACTORY PRIMED WHITE, PAINTED BLACK CORNER MOLDING - JAMES HARDIE HARDIETRIM § § TRIM - SMOOTH, PAINTED WHITE DECKING - TREX TRANSCEND LINEAGE - JASPER FENCING - VERANDA 36 IN, TRADITIONAL WHITE POLY-COMPOSITE RAIL GATE KIT W/ METAL BALUSTERS FRAMEWORK - 448 VERANDA WHITE FOLY-COMPOSITE RAIL GATE KIT W/ METAL BALUSTERS FRAMEWORK - VERANDA WHITE FOLY-COMPOSITE RAIL GATE KIT W/ METAL BALUSTERS FRAMEWORK - 480 VERANDA WHITE FOLY-COMPOSITE RAIL GATE KIT W/ METAL BALUSTERS FRAMEWORK - 480 VERANDA WHITE GOARDEN VINYL LATICE COLIMN - BROSCO DISI ALLIMINUM COLUMN - RECESSED BRACKET - BROSCO PROLOCIS BRACKETS - HART-2 MOLDING - BROSCO INTEX MILLED & PRIMED PVC MOULDING - 7901 EXTERIOR LIGHTING FIXTURES: HINKLEY FORGE 16-1/2" HIGH BLACK OUTDOOR BARN WALL LIGHT HINKLEY FORGE 12" HIGH BLACK OUTDOOR WALL LIGHT HINKLEY FORGE 12" HIGH BLACK OUTDOOR BARN WALL LIGHT HINKLEY FORGE 12" HIGH BLACK OUTDOOR WALL LIGHT	ARCHITECT:
EAST COAST ALUMINUM METAL ROOFING PVC MOLDING PAINTED @2'-6" ON CENTER 5" ALUMINUM GUTTER	ENGINEER'S STAMP:
FASCIA AND SOFFIT ARCHITECTURAL BRACKETS CROWN MOLDING ACCENT JAMES HARDIE HARDIE 8" CORNER BOARD ½ X ½ SMOOTH	GENERAL INFORMATION:
CLAPBOARD SIDING, PTD CLAPBOARD SIDING, PTD RECREATE SWINGING DOOR AT UPPER FLOOR NEW DOOR & FRAME NEW WINDOWS	
RUBBED CONC FND WALL	SCHEMATIC 07.20.2023 DESIGN DEVELOPMENT 10.25.2023 BID N/A PERMIT 07.09.2024 CONSTRUCTION EXISTING CONDITIONS
	3 2 1 REVISION DATE DATE: 07.09.2024 SCALE: 07.09.2024 SCALE: AS NOTED PROJECT: 2022.75 DRAWN: PL CHECKED: JGH PROJECT TITLE: 5-UNIT RESIDENTIAL IN HISTORIC DISTRICT 114 AUSTIN ST WORCESTER, MA 01609
QUINCY STREET ELEVATION SCALE: 1/4" = 1'-0"	SHEET TITLE: QUINCY STREET ELEVATION SHEET NUMBER: A-2.1



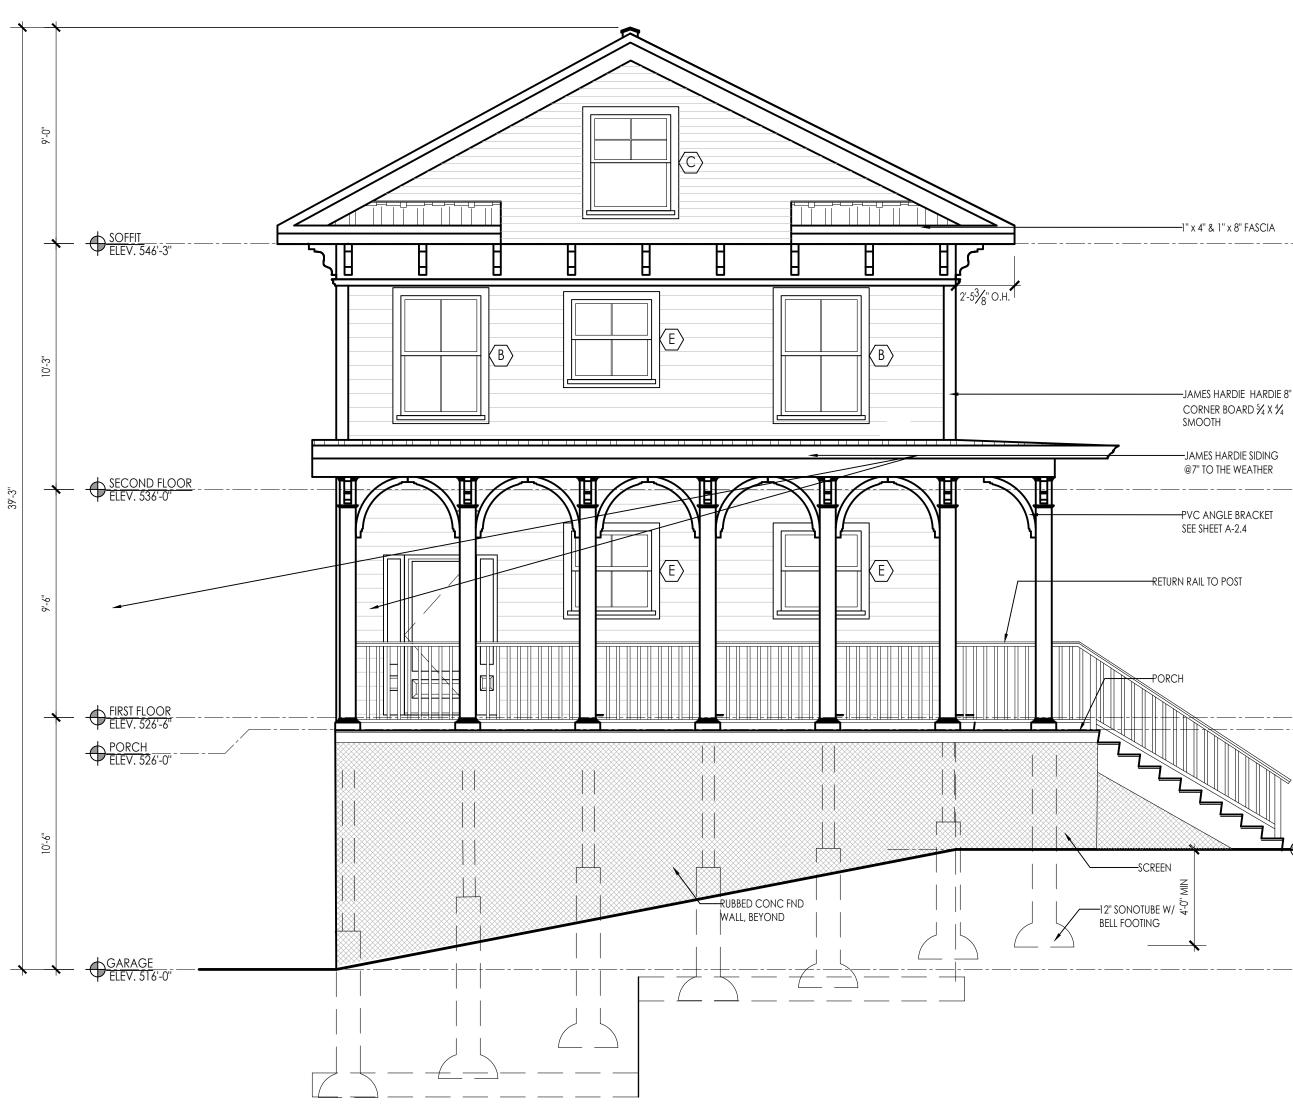


		ARCHITECT:
	LIST OF MATERIALS	00R 608 1368 10M
	ROOFING MATERIALS: SHINGLE - EAST COAST METAL ROOFING ALUMINUM ROOF SHINGLE - CHARCOAL GRAY	ST FLO 372.5 CIS.C
	SIDING MATERIALS:	
	CLAPBOARD SIDING - FIBER CEMENT LAP SIDING SIMILAR TO JAMES HARDIE STATEMENT COLLECTION PLANK LAP SIDING (7" EXPOSURE), COLOR - ARCTIC WHITE	
	GUARDS & HANDRAILS:	ASA MA
	HANDRAILS - VERANDA 36 IN. TRADITIONAL WHITE POLY-COMPOSITE RAIL GATE KIT W/ METAL BALUSTERS	DIXON SALO
	WINDOWS - MARVIN SIGNATURE SERIES, ULTIMATE WOOD, PAINTED WHITE DOORS - ANDERSEN WOOD ENTRY DOOR - PAINTED WHITE	DIXON SALO ARCHITECTS MORCESTER,
	GARAGE DOOR - OVERHEAD DOOR COMPANY MODEL 303 ARCHED - 8'X7', GRAY/WHITE, 12 WINDOW ARCHED, CLEAR, BARCELONA HINGE, BARCELONA PULL	
	Shutter - MILLWORK TRADERS STANDARD DUTY FIXED LOUVER 15"X48" - SPANISH CEDAR, PAINT GRADE, FACTORY PRIMED WHITE, PAINTED BLACK	ARCHITECT'S STAMP:
	Corner Molding - James Hardie Hardietrim $\frac{5}{4}$, $\frac{4}{4}$ trim - Smooth, painted white Decking - Trex transcend lineage - Jasper	
	FENCING - YELA YRANGELIND LINEAGE - JASEER FENCING - VERANDA 36 IN. TRADITIONAL WHITE POLY-COMPOSITE RAIL GATE KIT W/ METAL BALUSTERS FRAMEWORK - 4x8 VERANDA WHITE GARDEN VINYL LATTICE	
	COLUMN - BROSCO DSI ALUMINUM COLUMN - RECESSED BRACKET - BROSCO PVC OUTDOOR PRODUCTS BRACKETS - HBKT-2	
	MOLDING - BROSCO INTEX MILLED & PRIMED PVC MOULDING - 7901	
E	EXTERIOR LIGHTING FIXTURES: HINKLEY FORGE 16-1/2" HIGH BLACK OUTDOOR BARN WALL LIGHT	
	HINKLEY FORGE 12" HIGH BLACK OUTDOOR WALL LIGHT	
F	RETAINING WALL: STONE STRONG 6-28SF CHISELED GRANITE TEXTURE BLOCKS W/CAP	
		ENGINEER:
		ENGINEER'S STAMP:
E 8" 1⁄4		
*		
;		GENERAL INFORMATION:
♥ ELEV. 521 <u>-0''</u>		
		SCHEMATIC 07.20.2023 DESIGN DEVELOPMENT 10.25.2023
		BID N/A PERMIT 07.09.2024
		CONSTRUCTION EXISTING CONDITIONS
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		REVISION DATE
		DATE: 07.09.2024
		SCALE: AS NOTED PROJECT: 2022.75
		DRAWN: PL
		CHECKED: JGH
		PROJECT TITLE:
		5-UNIT RESIDENTIAL IN HISTORIC DISTRICT
		114 AUSTIN ST
		WORCESTER, MA 01609
		SHEET TITLE:
		AUSTIN STREET ELEVATION
	AUSTIN STREET ELEVATION	SHEET NUMBER:
		A-2.2

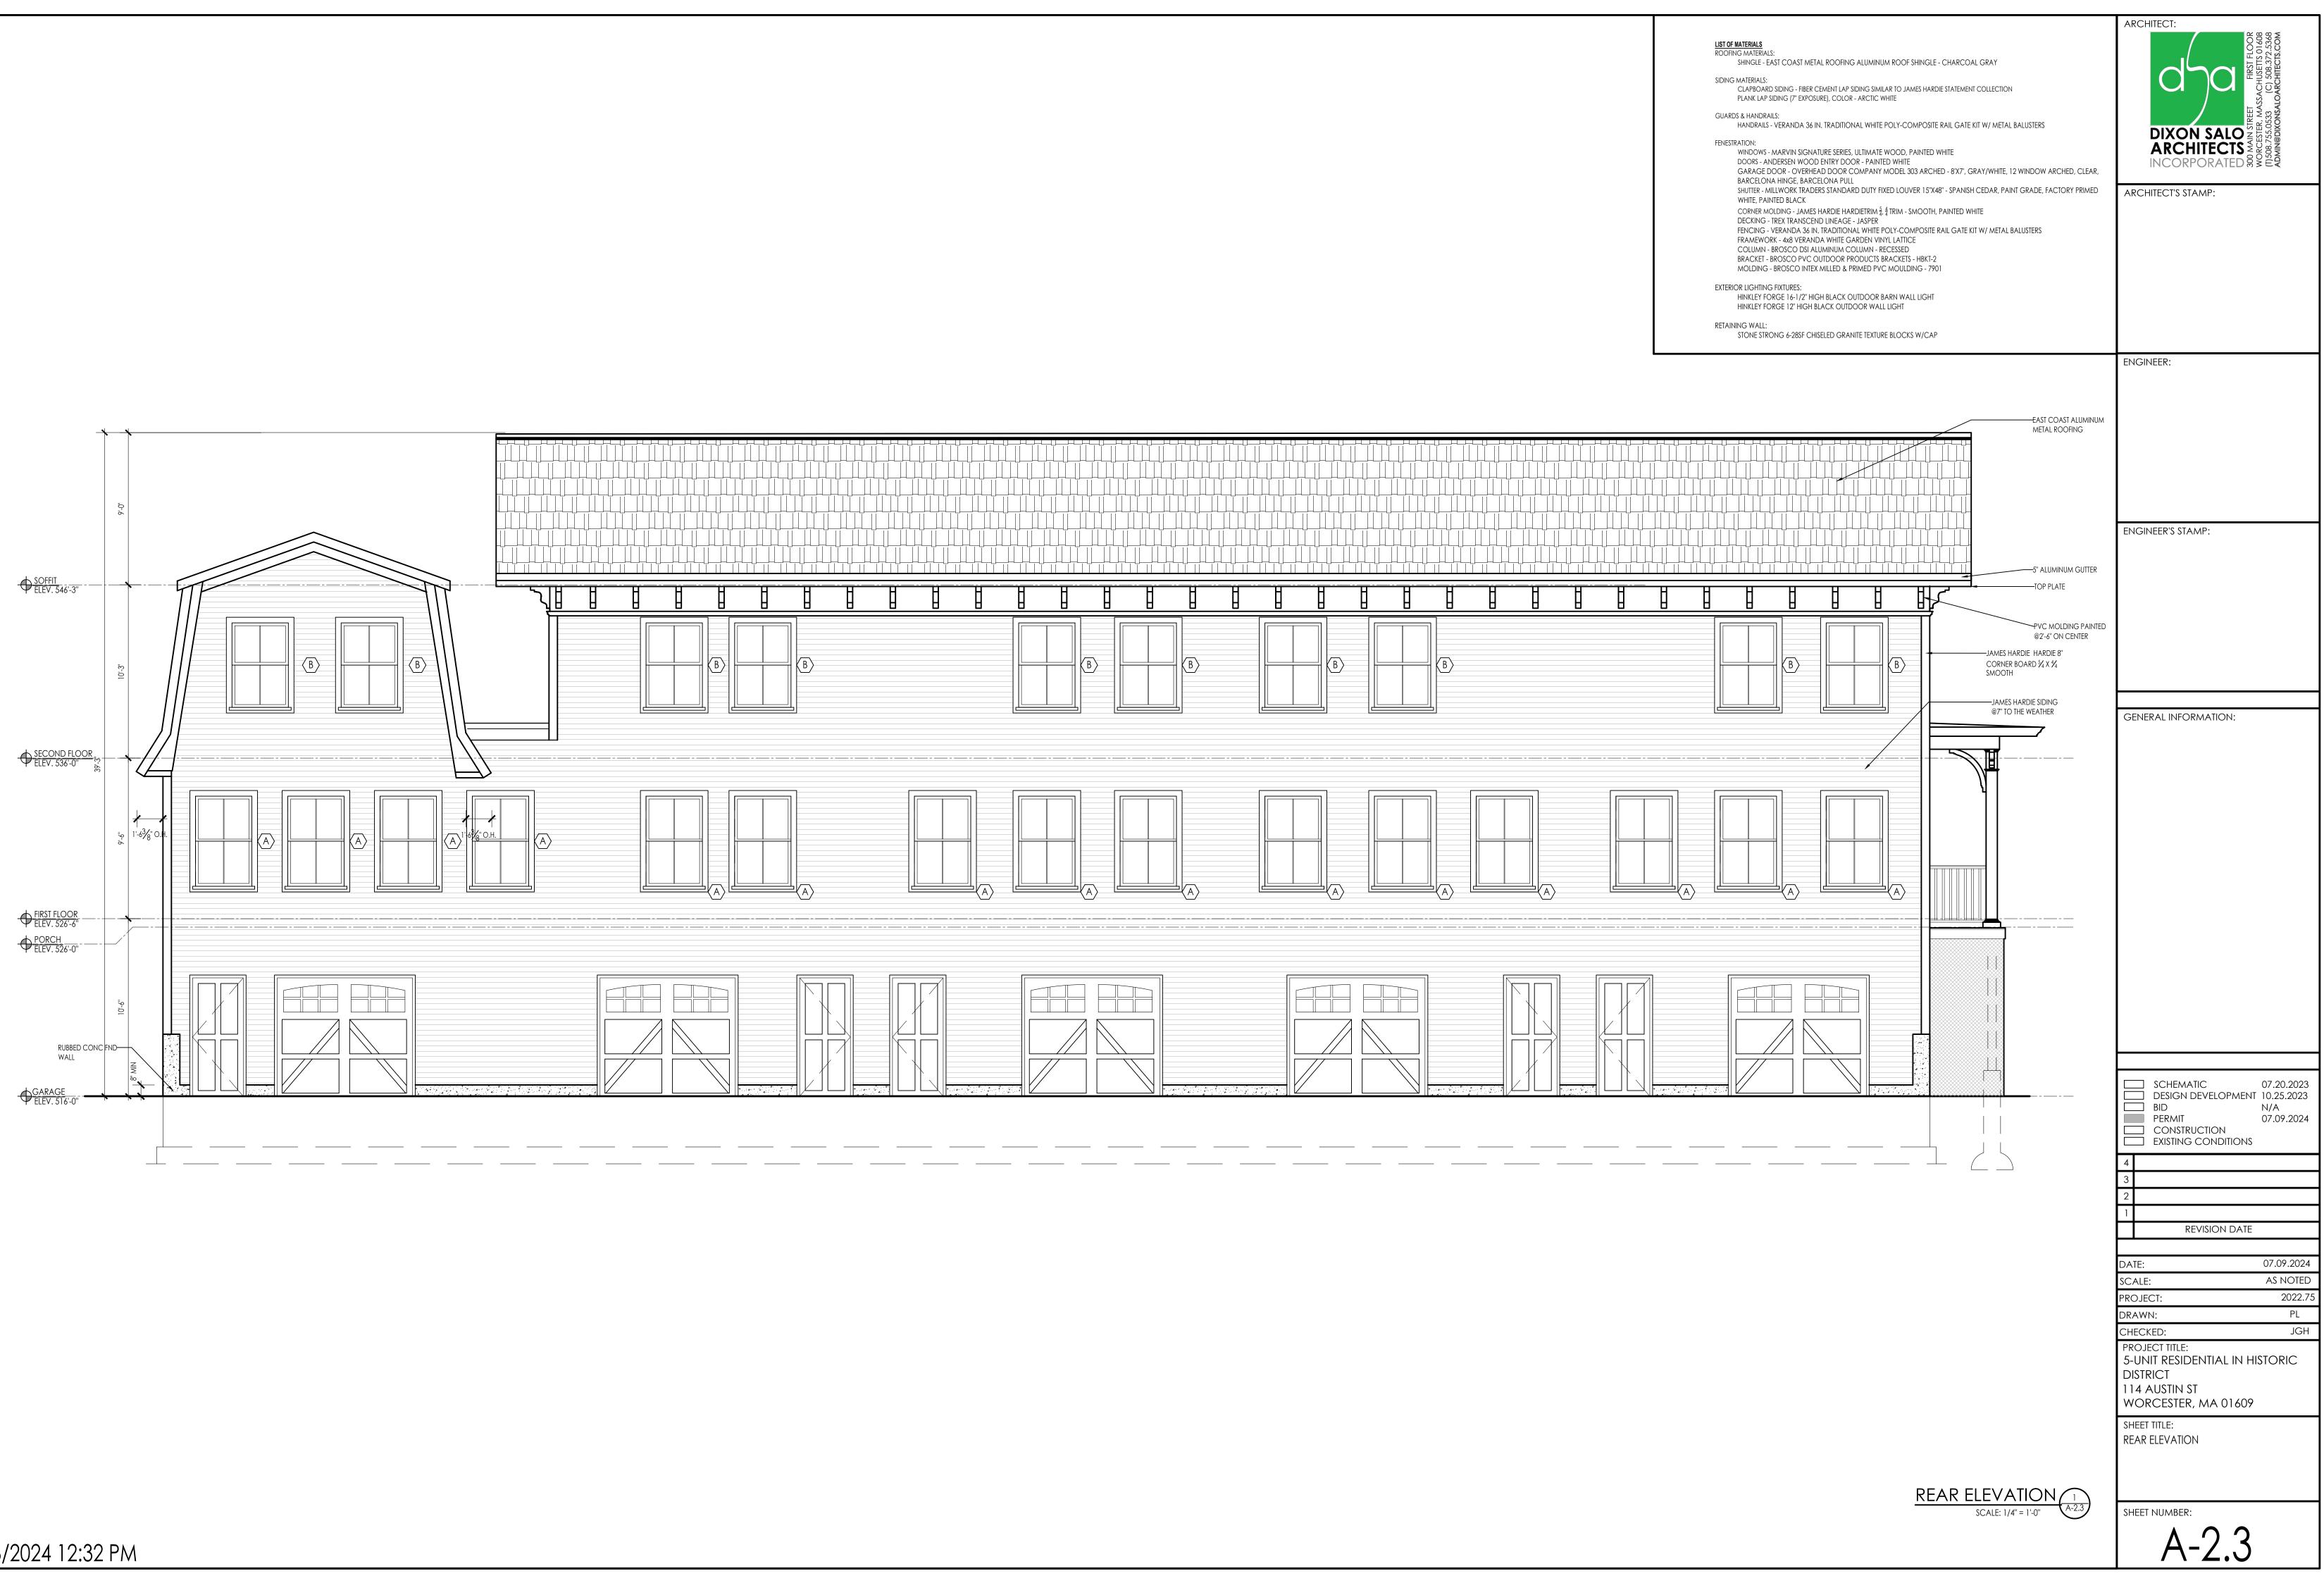

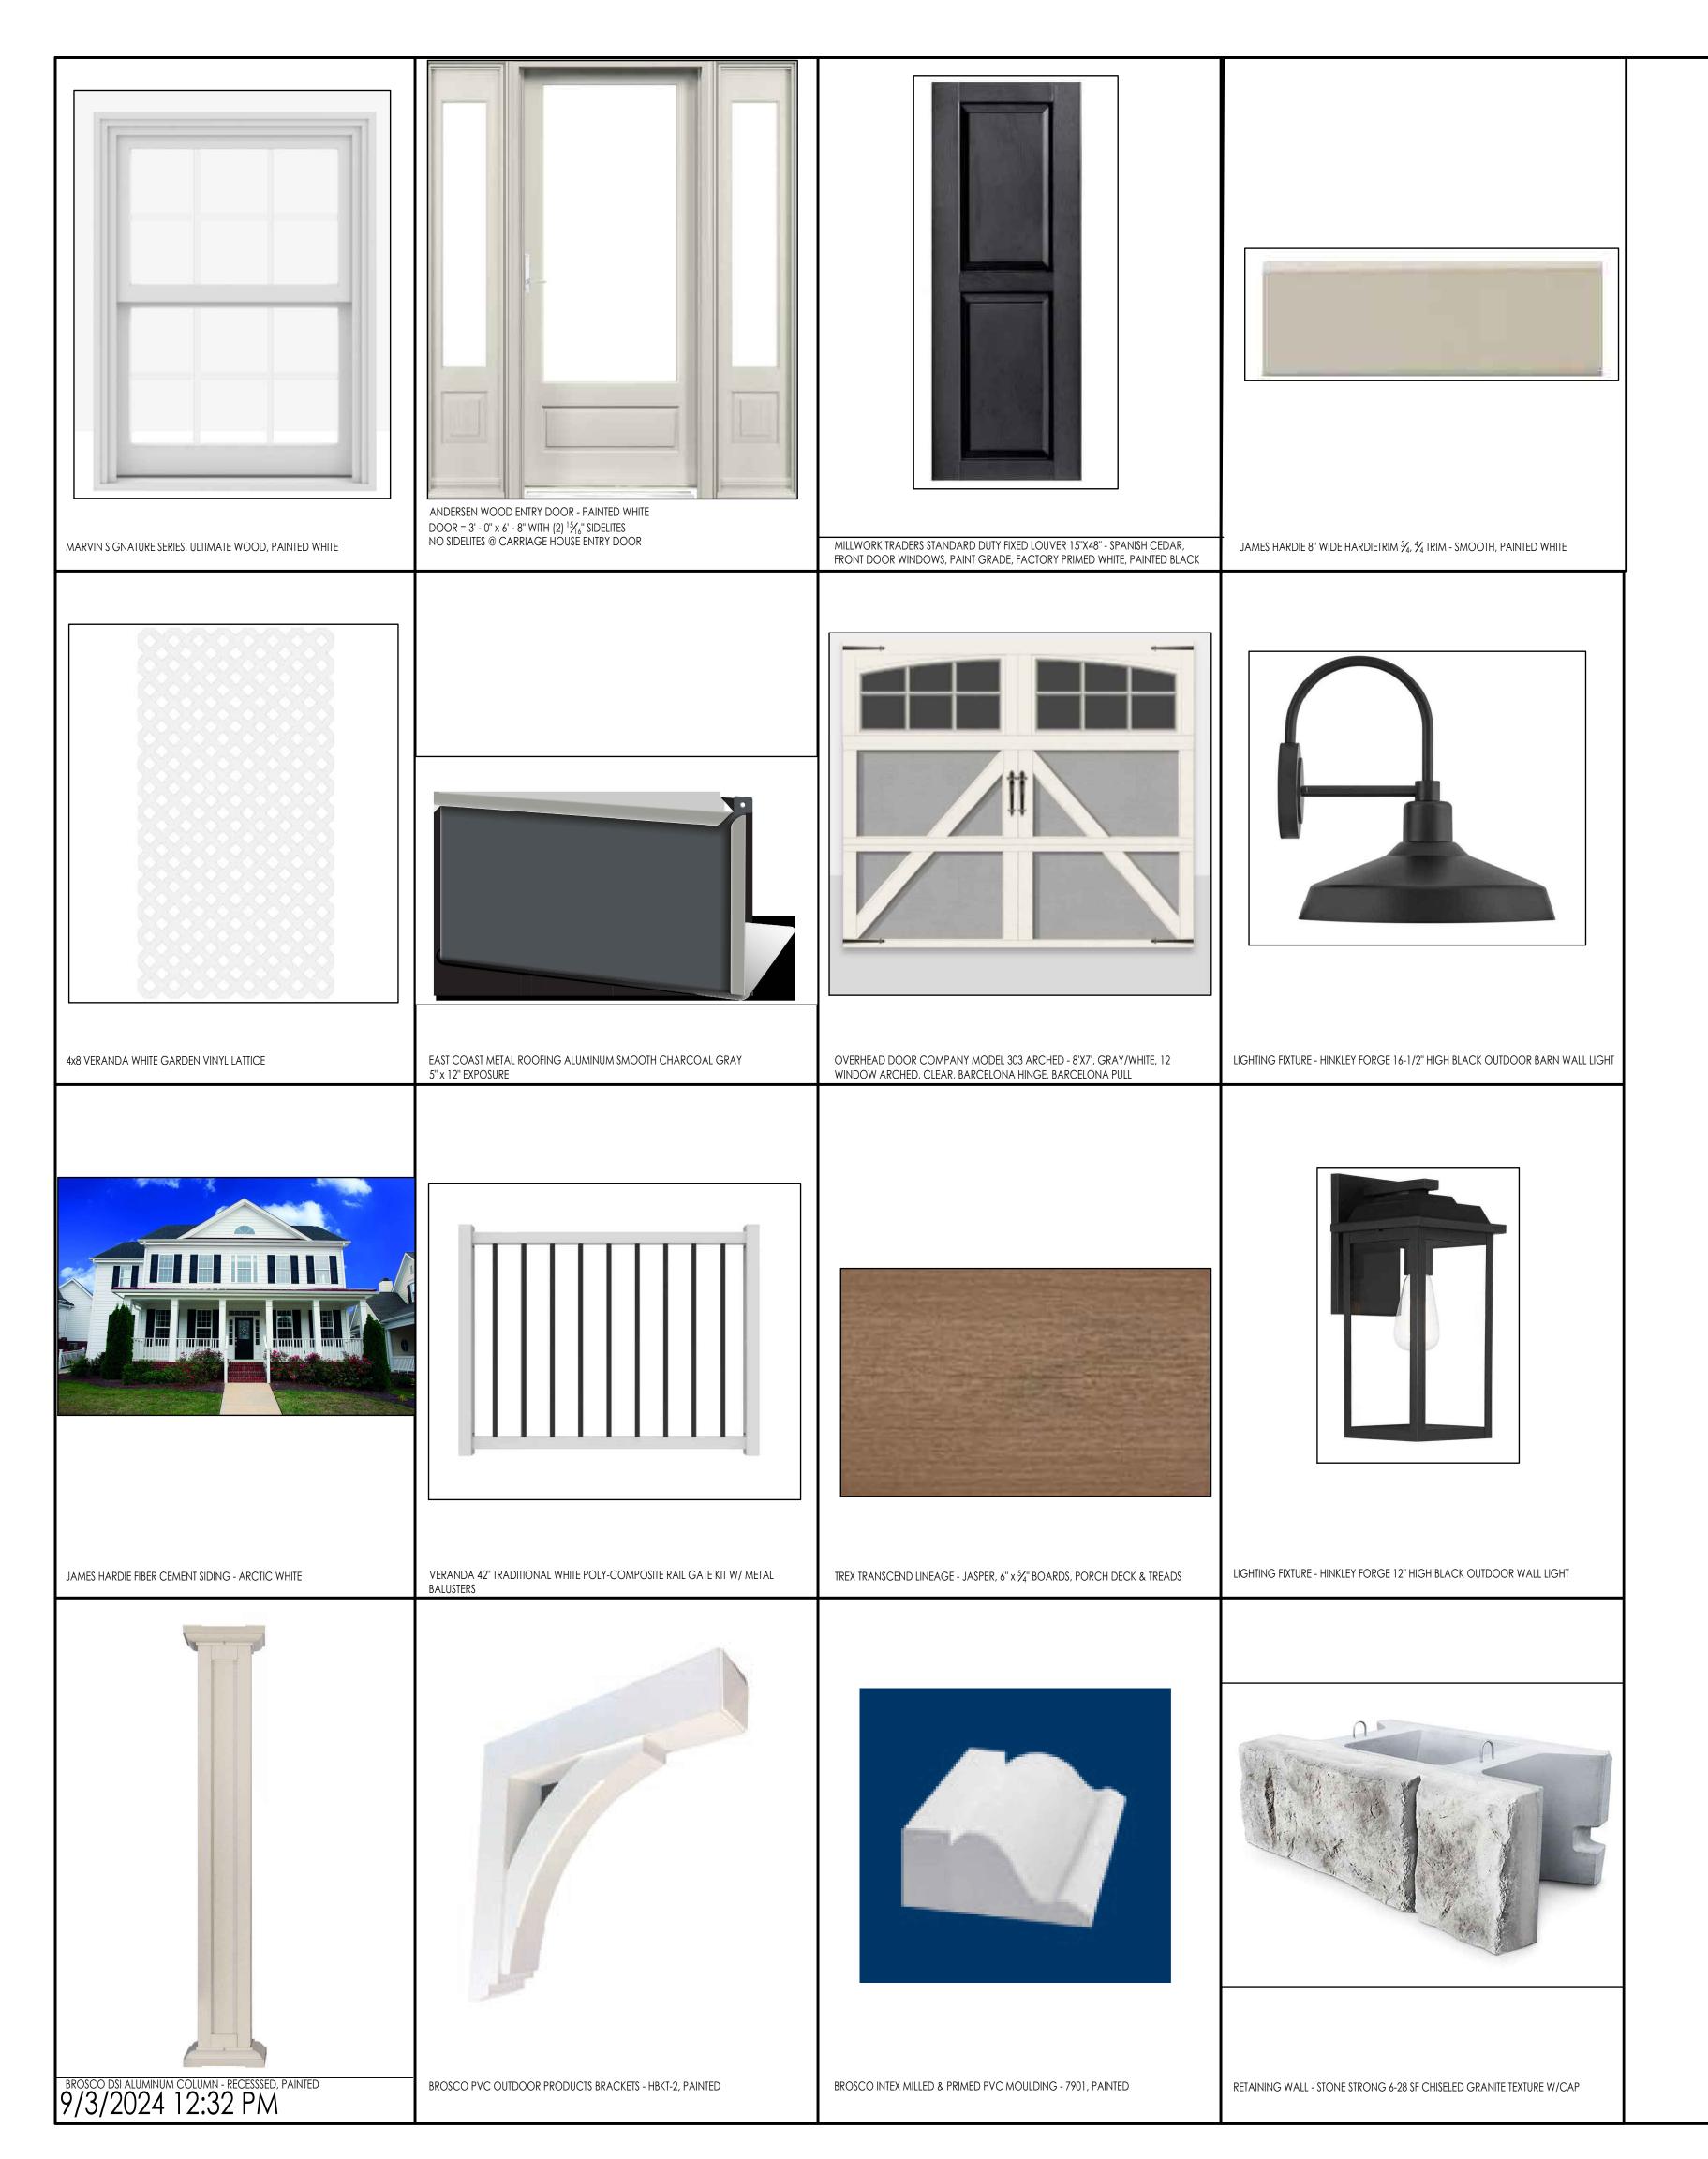



	ARCHITECT:
LIST OF MATERIALS ROOFING MATERIALS:	FLOOR 5 01608 172,5368
SHINGLE - EAST COAST METAL ROOFING ALUMINUM ROOF SHINGLE - CHARCOAL GRAY	DIXON SALO SOLUCION MORCESTER, MASSACHUSETTS 016 (1)508.755.0533 (C) 508.372.53 ADMIN@DIXONSALOARCHITECTS.CC
CLAPBOARD SIDING - FIBER CEMENT LAP SIDING SIMILAR TO JAMES HARDIE STATEMENT COLLECTION PLANK LAP SIDING (7" EXPOSURE), COLOR - ARCTIC WHITE	
GUARDS & HANDRAILS: HANDRAILS - VERANDA 36 IN. TRADITIONAL WHITE POLY-COMPOSITE RAIL GATE KIT W/ METAL BALUSTERS	SIREET SSIREET 0533 XONSA
FENESTRATION:	
WINDOWS - MARVIN SIGNATURE SERIES, ULTIMATE WOOD, PAINTED WHITE DOORS - ANDERSEN WOOD ENTRY DOOR - PAINTED WHITE GARAGE DOOR - OVERHEAD DOOR COMPANY MODEL 303 ARCHED - 8'X7', GRAY/WHITE, 12 WINDOW ARCHED, CLEAR,	
BARCELONA HINGE, BARCELONA PULL SHUTTER - MILLWORK TRADERS STANDARD DUTY FIXED LOUVER 15"X48" - SPANISH CEDAR, PAINT GRADE, FACTORY PRIMED	ARCHITECT'S STAMP:
WHITE, PAINTED BLACK CORNER MOLDING - JAMES HARDIE HARDIETRIM $\frac{5}{4}$, $\frac{4}{4}$ TRIM - SMOOTH, PAINTED WHITE	ARCHITECTS STAML.
DECKING - TREX TRANSCEND LINEAGE - JASPER FENCING - VERANDA 36 IN, TRADITIONAL WHITE POLY-COMPOSITE RAIL GATE KIT W/ METAL BALUSTERS	
FRAMEWORK - 4x8 VERANDA WHITE GARDEN VINYL LATTICE COLUMN - BROSCO DSI ALUMINUM COLUMN - RECESSED BRACKET - BROSCO PVC OUTDOOR PRODUCTS BRACKETS - HBKT-2	
MOLDING - BROSCO INTEX MILLED & PRIMED PVC MOULDING - 7901	
EXTERIOR LIGHTING FIXTURES: HINKLEY FORGE 16-1/2" HIGH BLACK OUTDOOR BARN WALL LIGHT HINKLEY FORGE 12" HIGH BLACK OUTDOOR WALL LIGHT	
RETAINING WALL:	
STONE STRONG 6-28SF CHISELED GRANITE TEXTURE BLOCKS W/CAP	
	ENGINEER:
	ENGINEER'S STAMP:
	GENERAL INFORMATION:
	SCHEMATIC 07.20.2023 DESIGN DEVELOPMENT 10.25.2023
	BID N/A PERMIT 07.09.2024
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	1 REVISION DATE
	DATE: 07.09.2024
	SCALE: AS NOTED PROJECT: 2022.75
	PROJECT: 2022.75 DRAWN: PL
	CHECKED: JGH
	PROJECT TITLE: 5-UNIT RESIDENTIAL IN HISTORIC
	DISTRICT
	114 AUSTIN ST WORCESTER, MA 01609
	SHEET TITLE:
	PROPOSED MATERIALS PHOTOS
	SHEET NUMBER:
	A-2.4

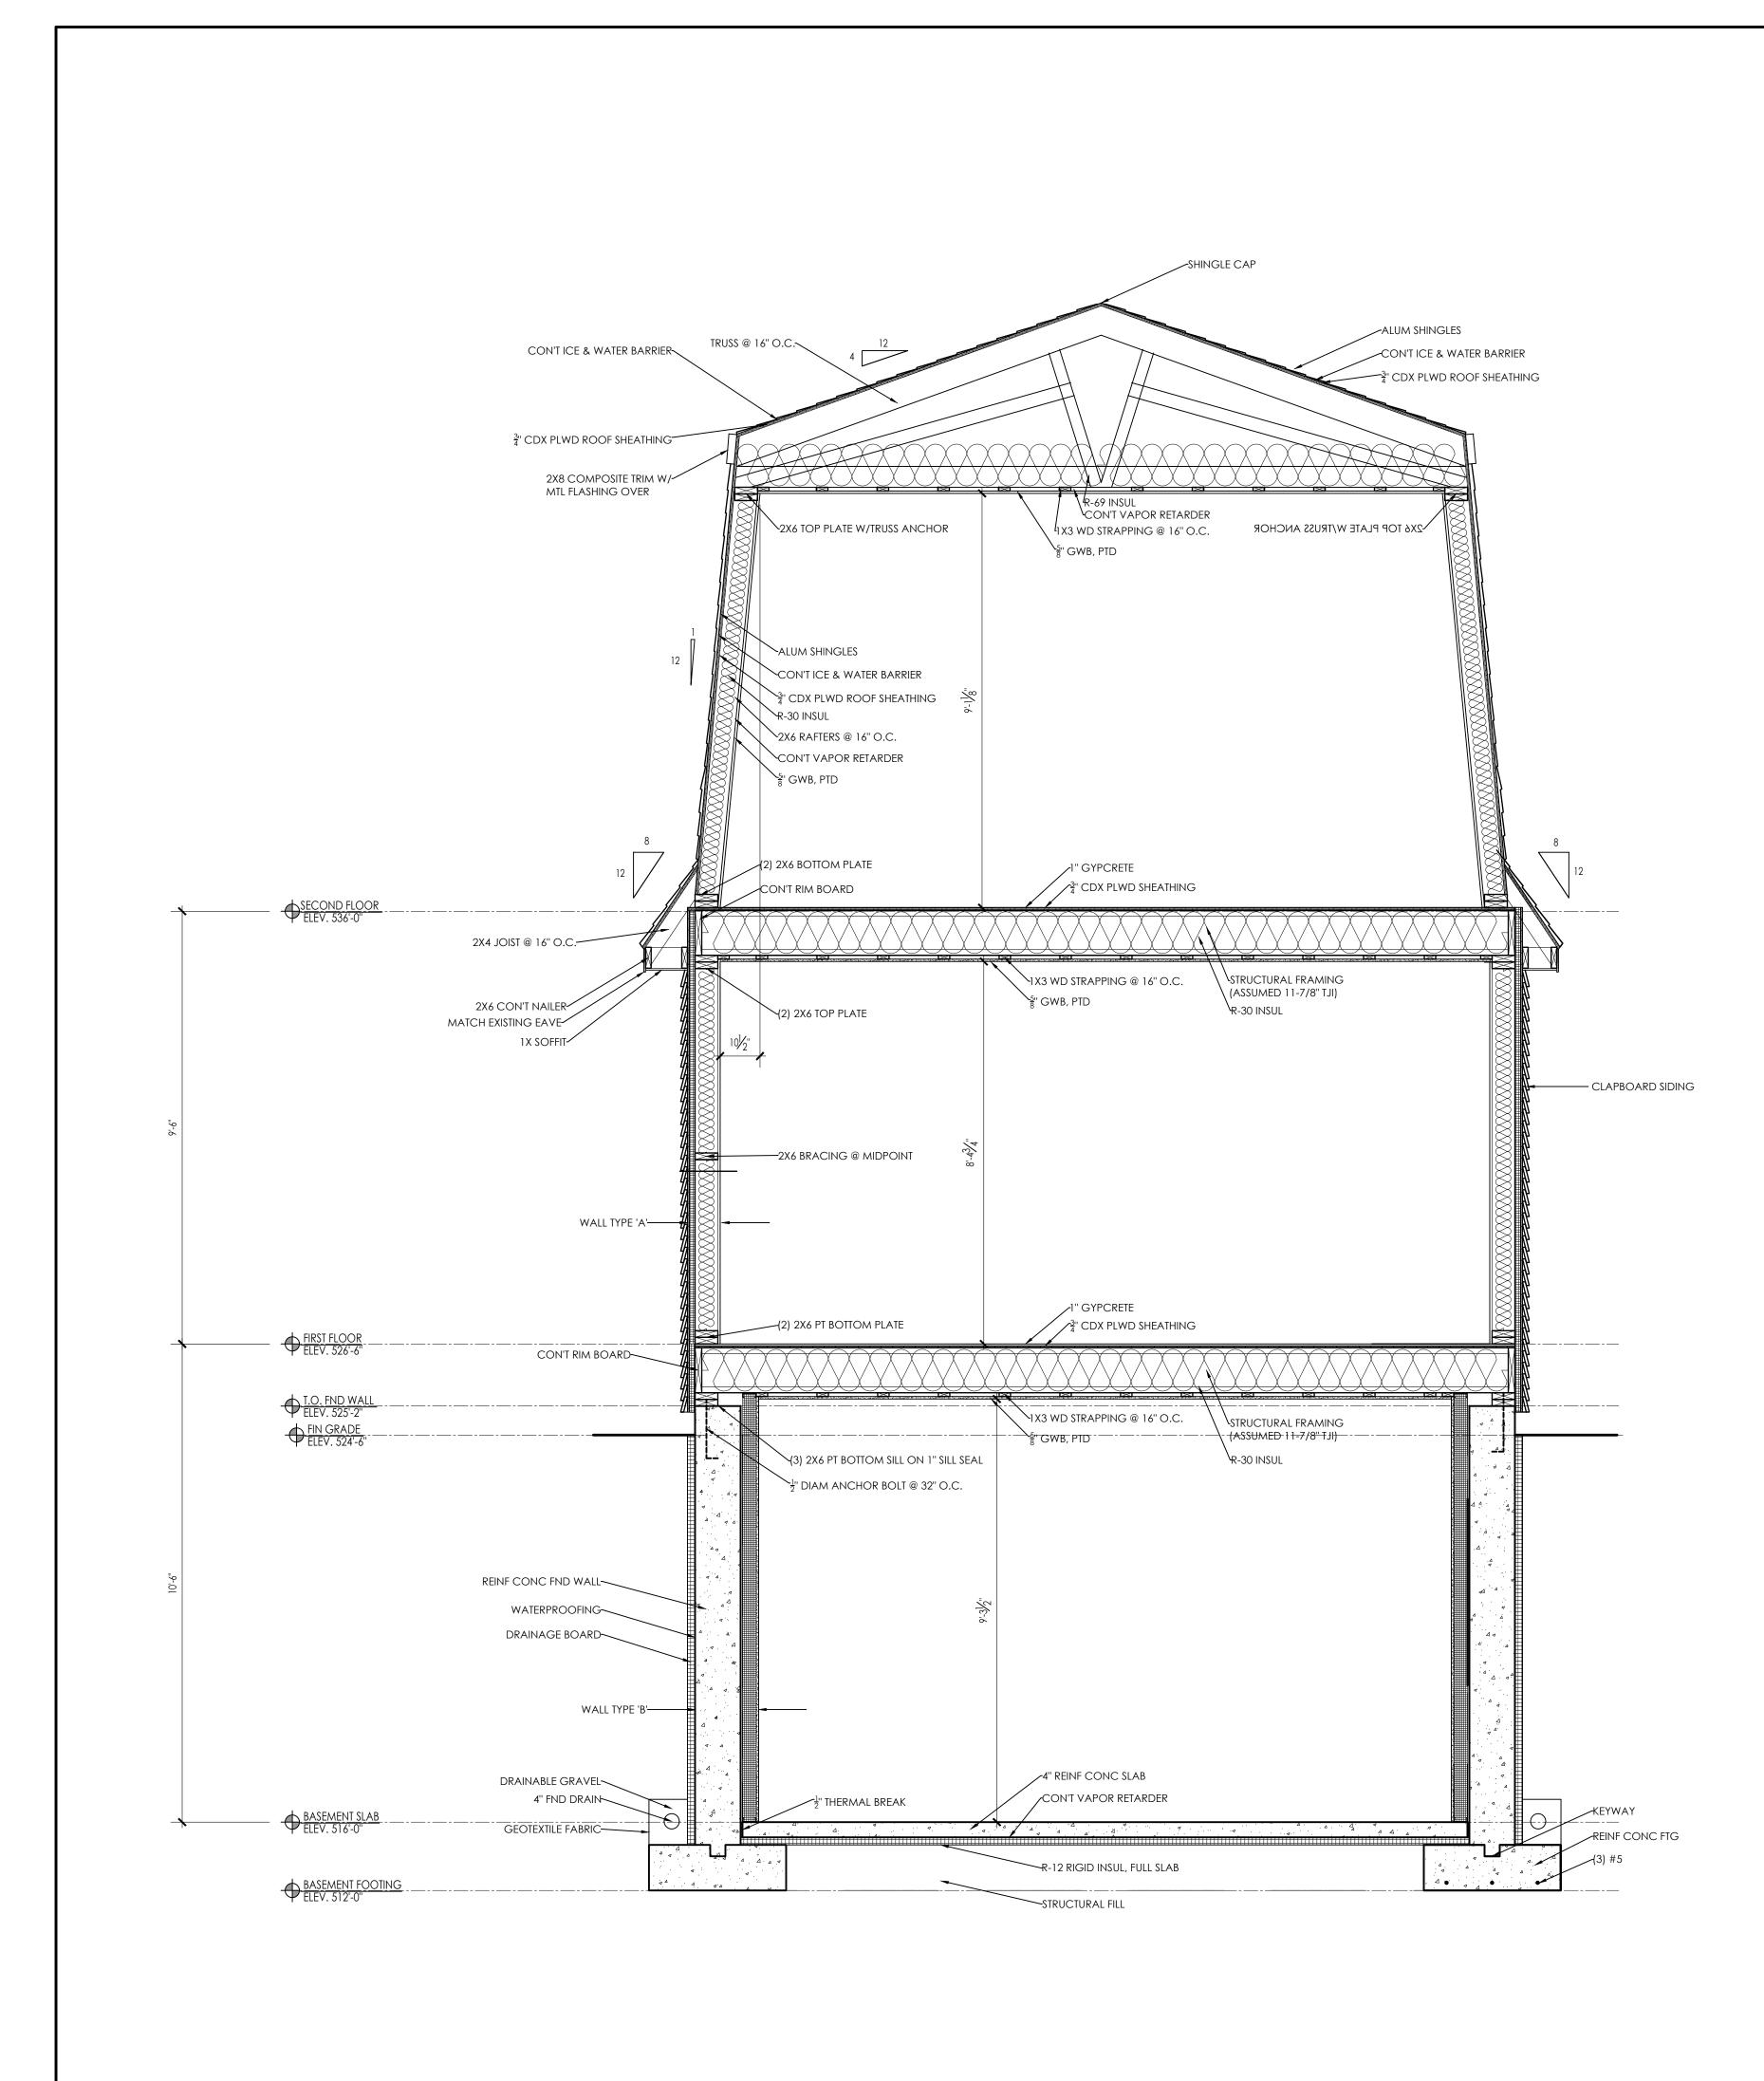



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(ACHUSEIIS (C) 508.372 ARCHITECTS
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SHEET TITLE			
CARRIAGI	E HOUSE SEG	LTION	
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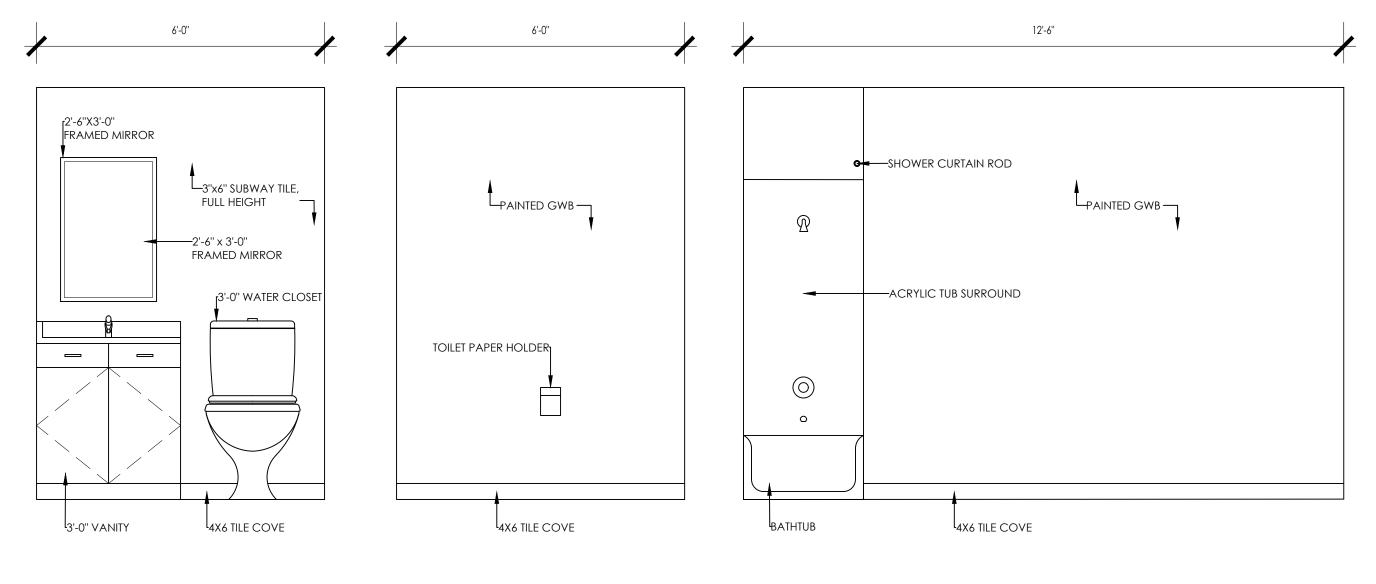
CARRIAGE HOUSE SECTION	
SCALE: 1/2" = 1'-0"	A-2.5



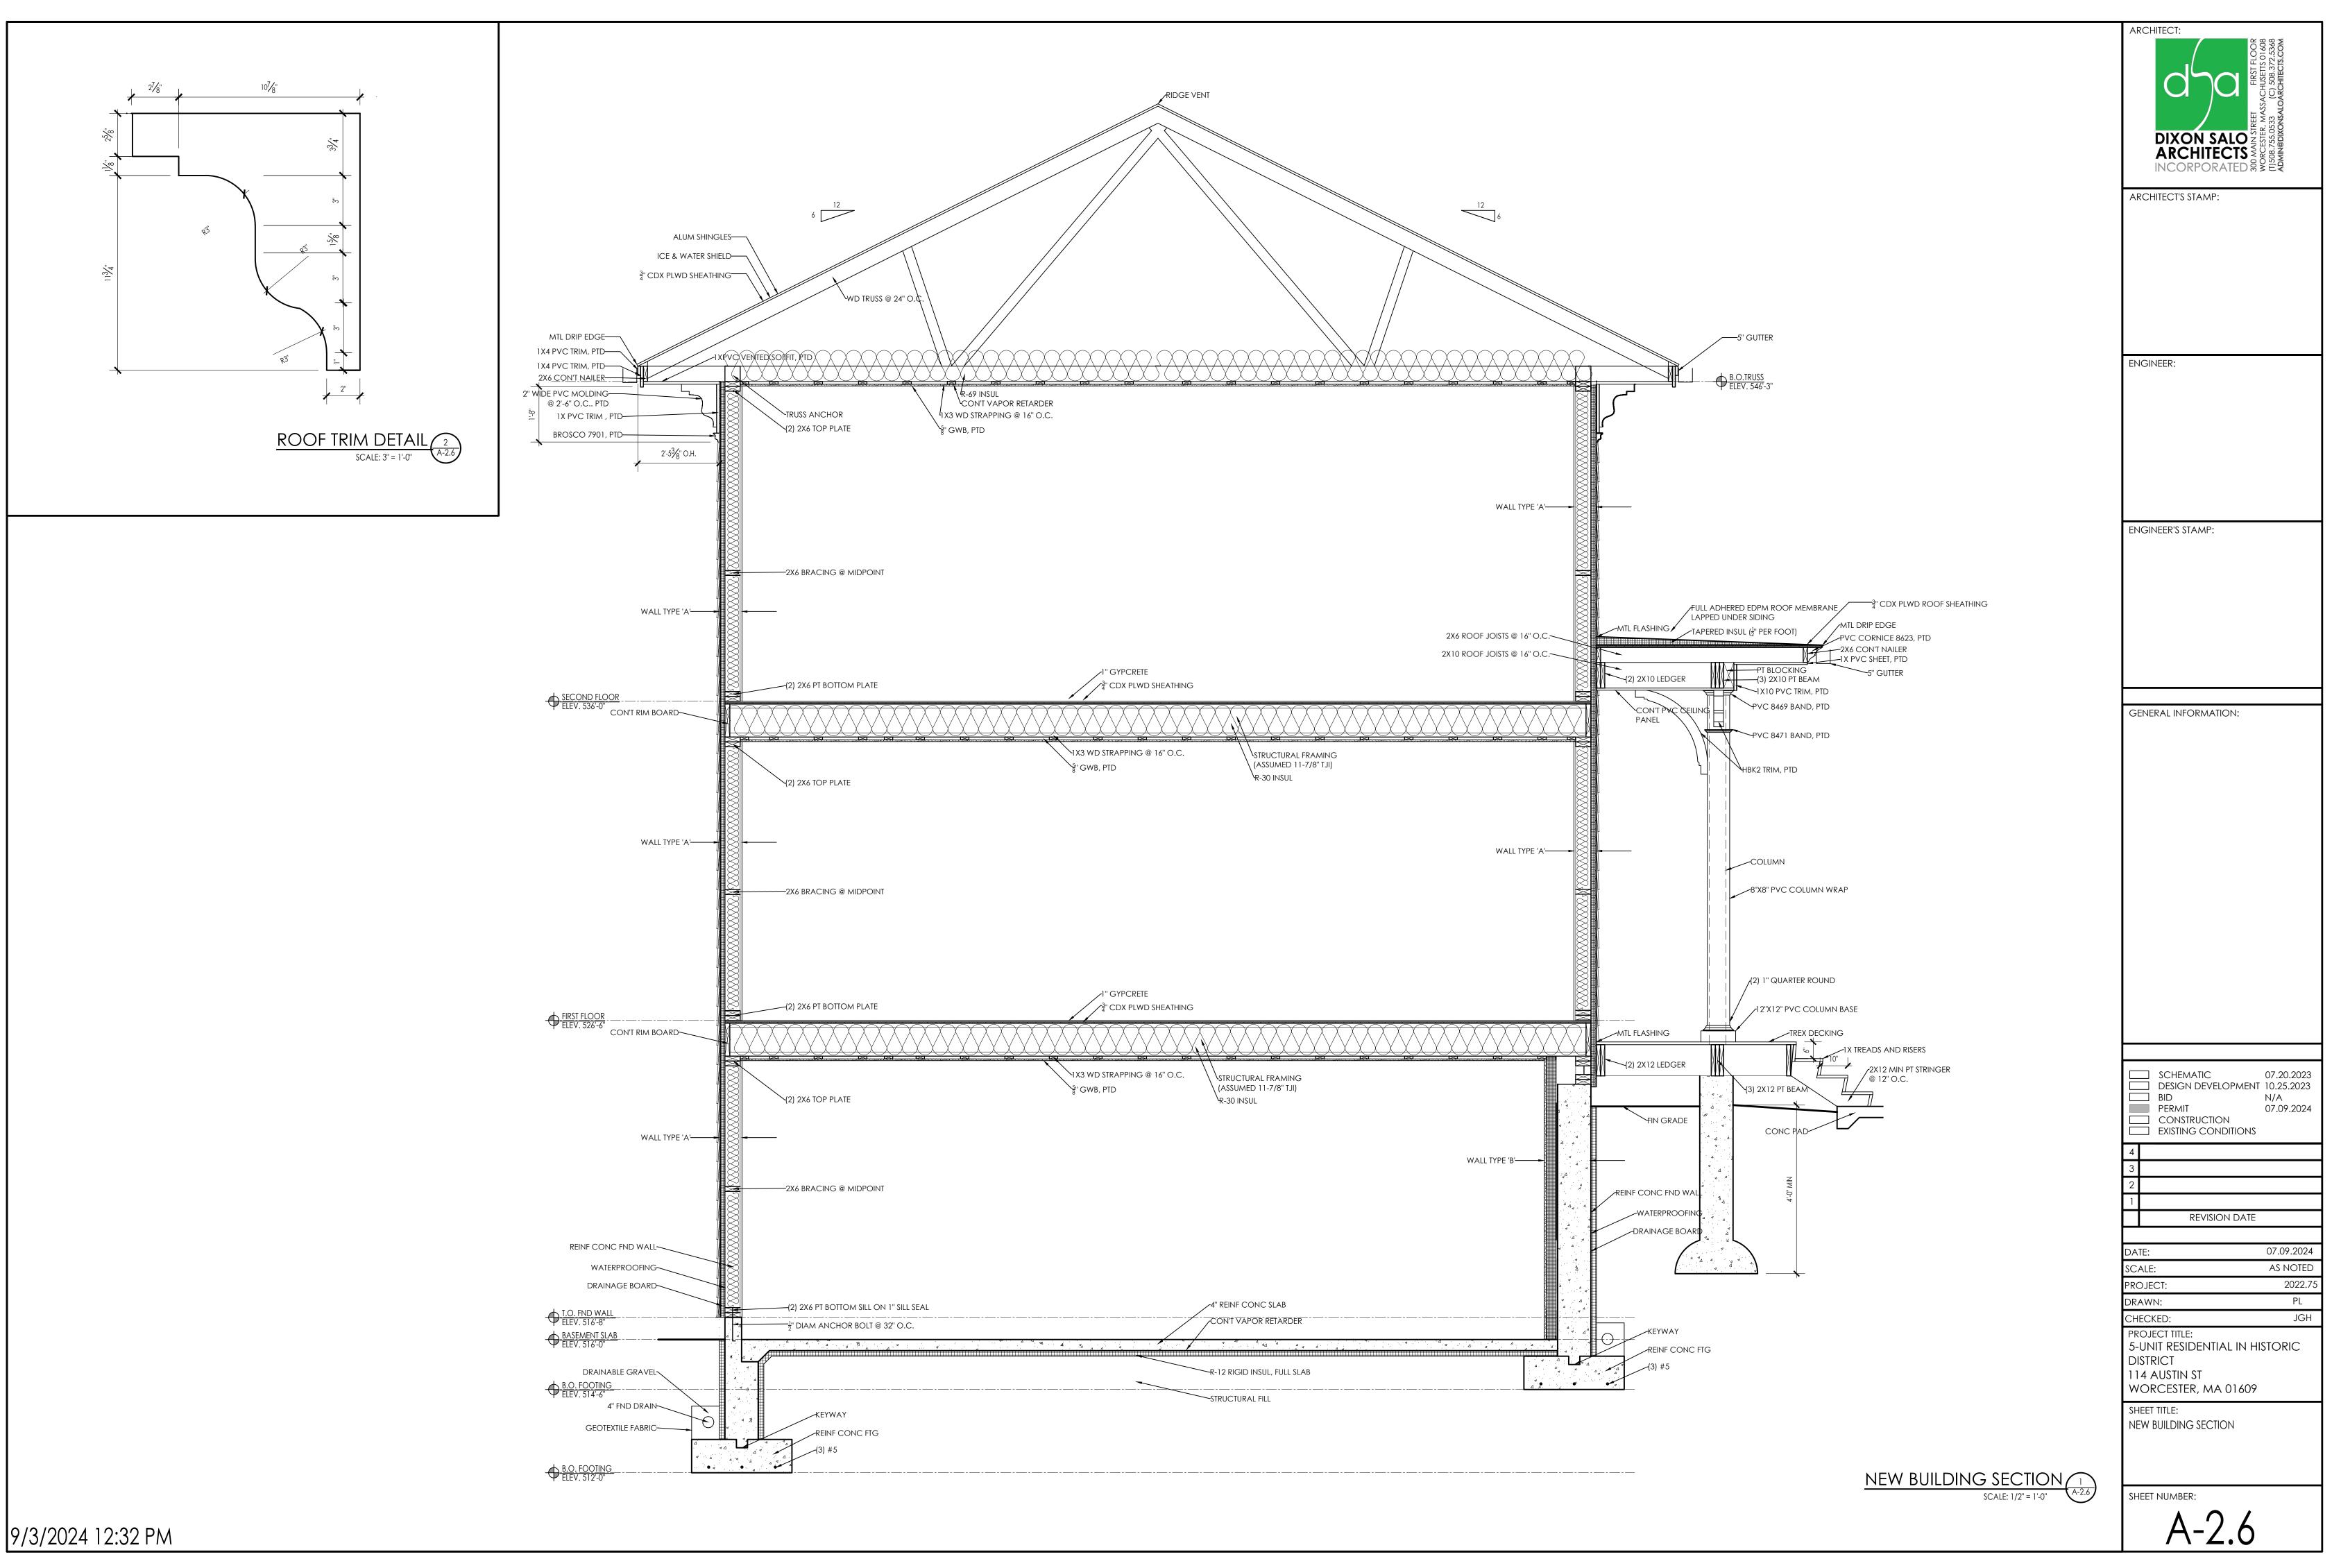

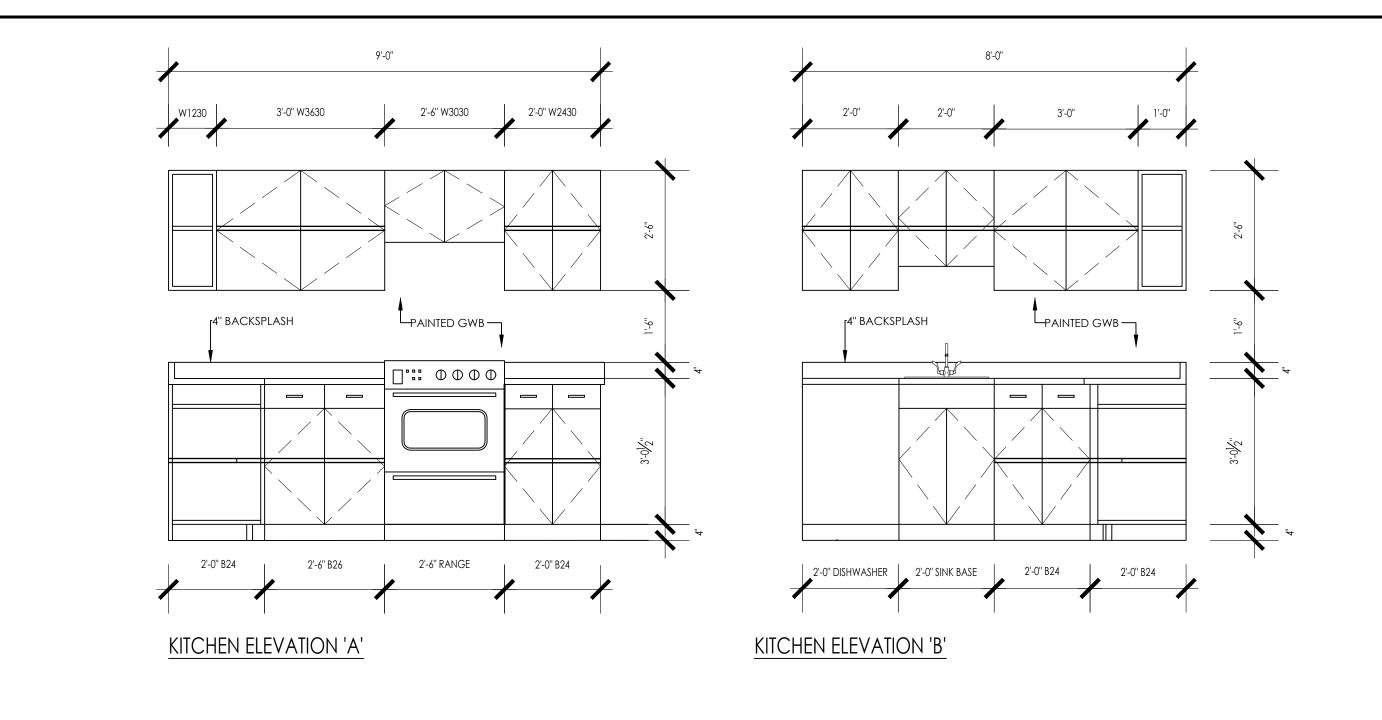

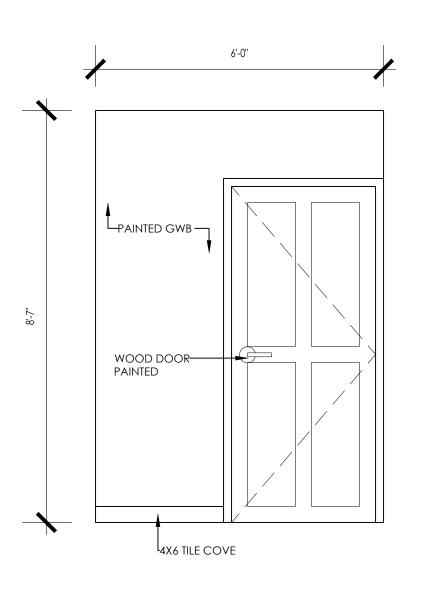

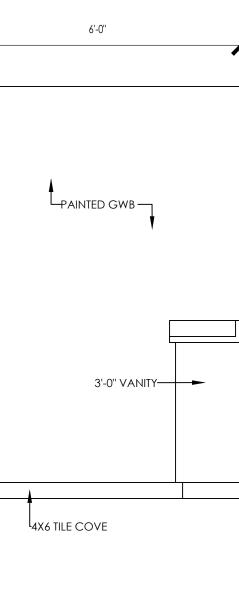


ELEVATION 'E'

ELEVATION 'A'

ELEVATION 'B'

ELEVATION 'C'

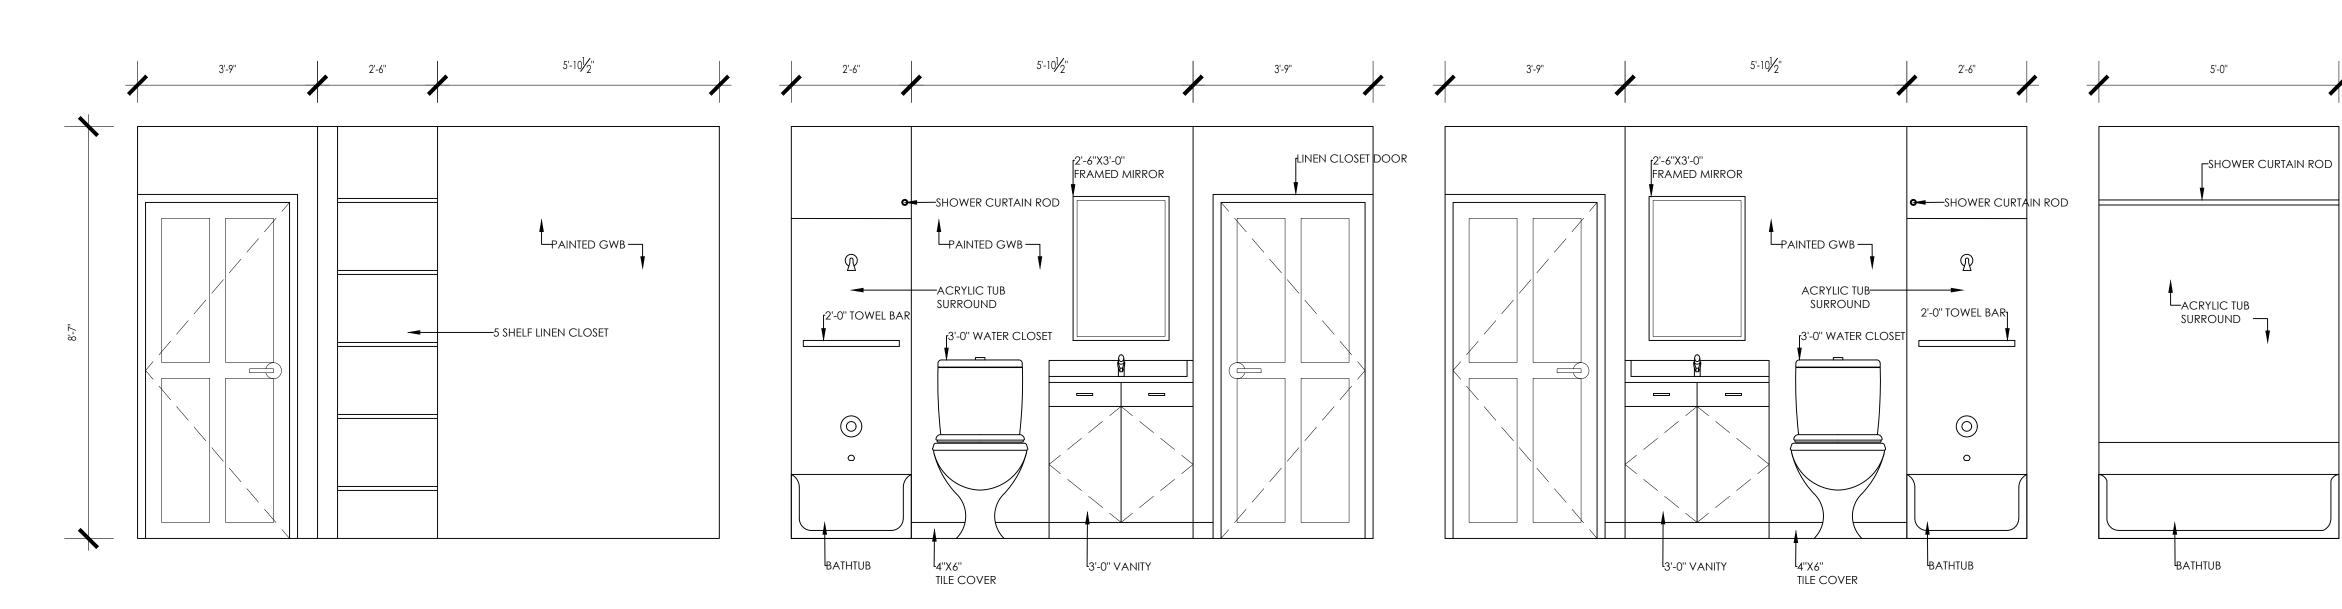


ELEVATION 'D'

9/3/2024 12:32 PM

ELEVATION 'G'


ELEVATION 'G'

ARCHITECT: DIXON SALO BUXON SALO SUCCEPTER, MASSACHITECTS, 01608 COLOR MASSACHITECTS MONORCESTER, MASSACHITECTS, 2083 COLOR MASSACHITECTS, STAMP. ARCHITECT'S STAMP:
ENGINEER:
ENGINEER:
ENGINEER'S STAMP:
GENERAL INFORMATION:
SCHEMATIC 07.20.2023
DESIGN DEVELOPMENT 10.25.2023 BID N/A PERMIT 07.09.2024 CONSTRUCTION EXISTING CONDITIONS
2 1 REVISION DATE
DATE: 07.09.2024 SCALE: AS NOTED PROJECT: 2022.75 DRAWN: PL CHECKED: JGH PROJECT TITLE: 5 UNIT PESIDENTIAL IN HISTOPIC
5-UNIT RESIDENTIAL IN HISTORIC DISTRICT 114 AUSTIN ST WORCESTER, MA 01609 SHEET TITLE: KITCHEN AND BATHROOM INTERIOR ELEVATIONS
SHEET NUMBER: A-6.0

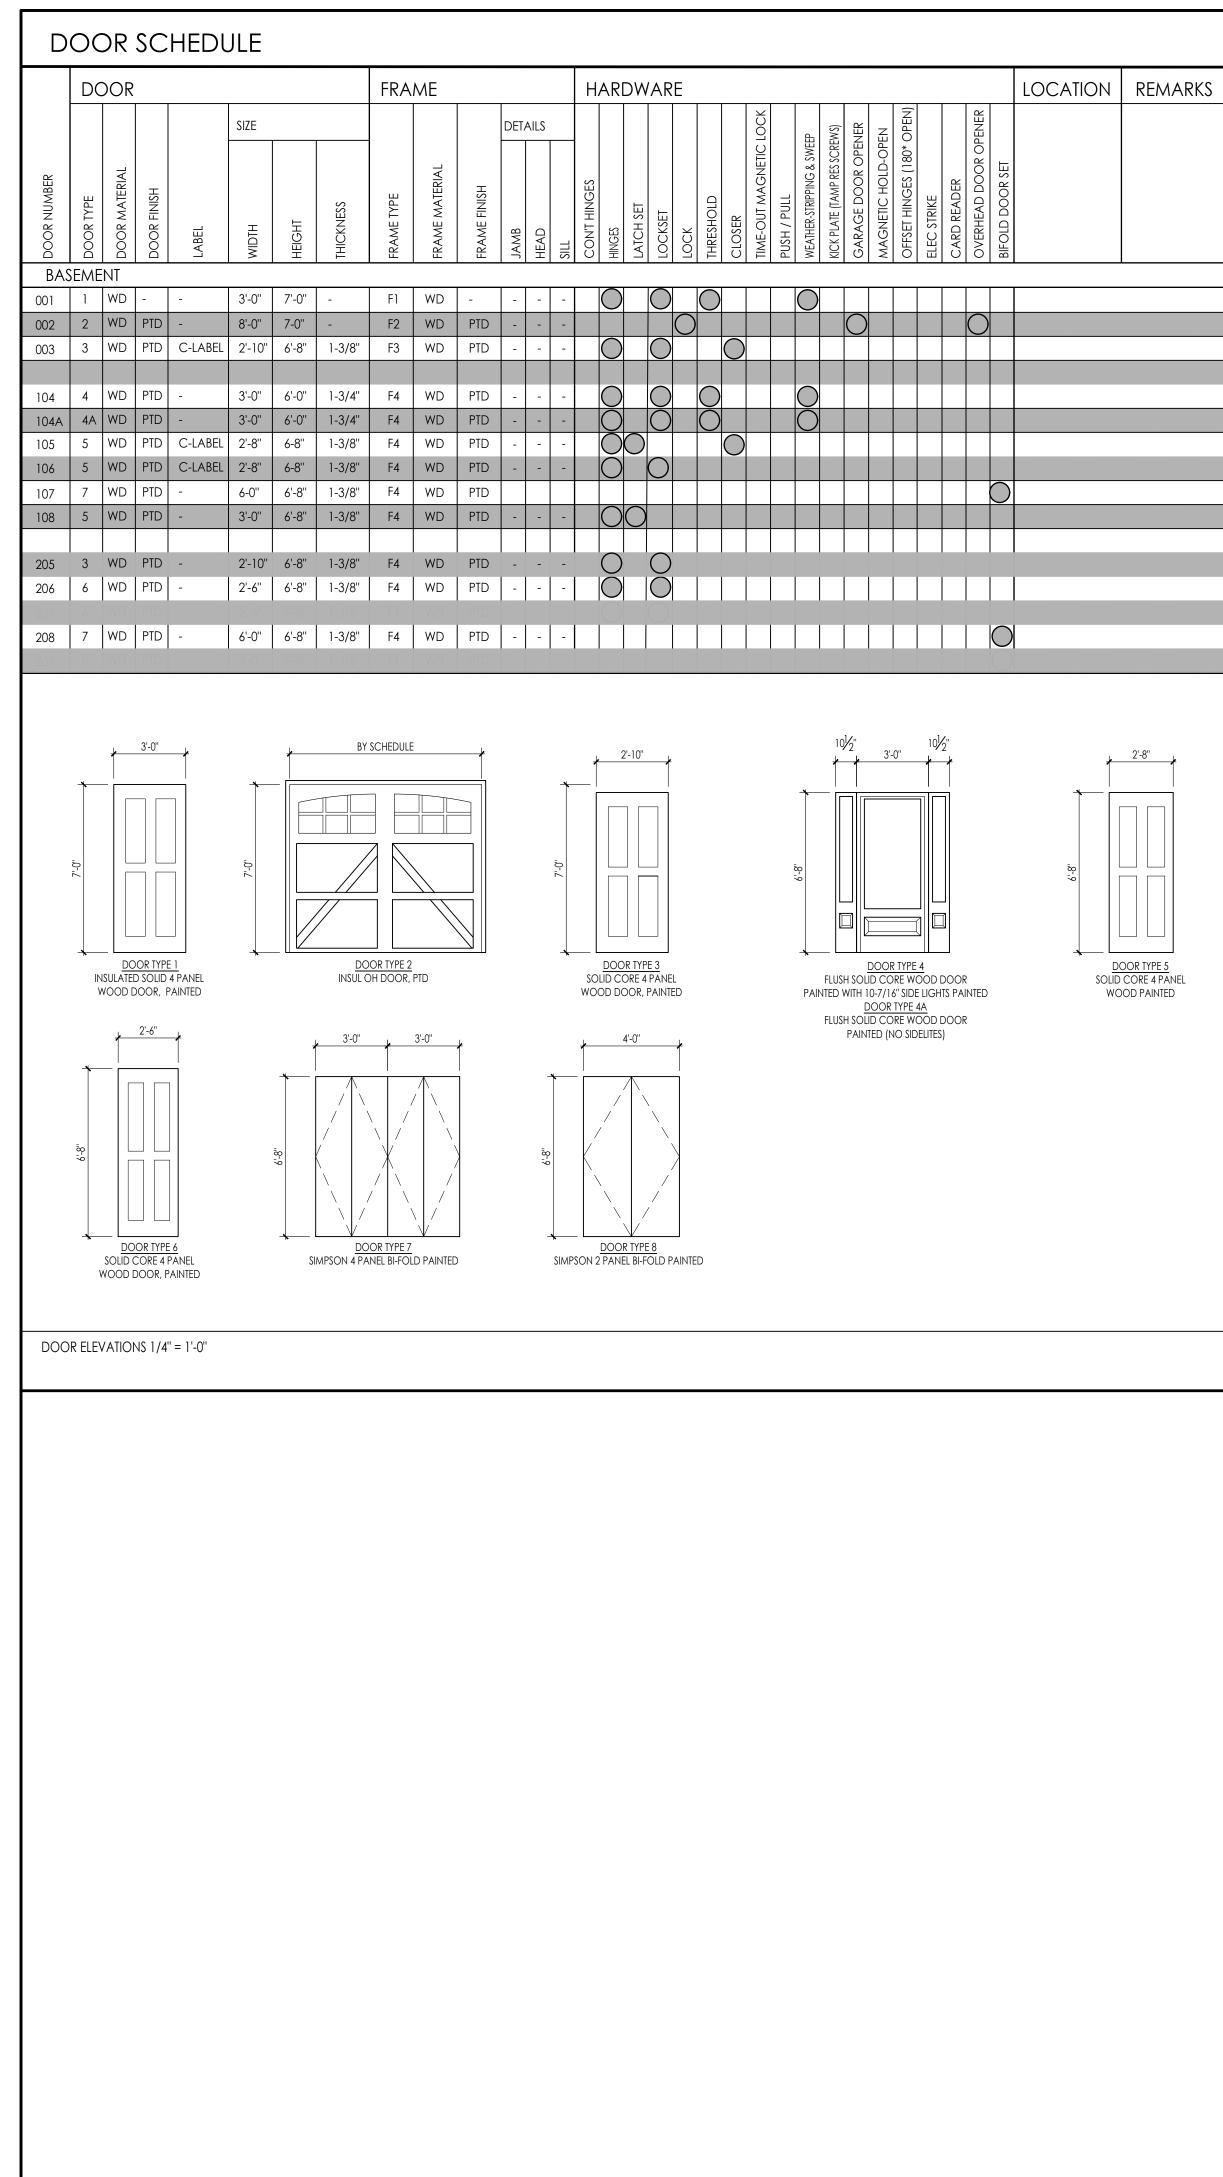

AREA	Fl	_00	DR			B	٩SE			W	ALI	S	(CEII	3		Remarks
	LUXURY VINYL TILE	CARPET	12" × 12" CERAMIC TILE	SEALED CONCRETE	WOOD TREADS AND RISERS	4" VINYL COVE	4" WOOD BASE	3" x 6" CERAMIC COVE	NONE	GWB, PAINTED	GWB TAPED & SANDED	WET WALL - FULL HEIGHT CERAMIC TILE, SUBWAY TILE	GWB PAIINTED	GWB TAPED & SANDED			
GARAGE)		\bigcirc						
MECH/ELEC				$\widetilde{\square}$				$\check{\cap}$			$\widetilde{\cap}$			$\check{\cap}$			
SPRINKLER				$\check{\bigcirc}$				$\check{\square}$)		ŏ			$\check{\square}$		Т	
BASEMENT STAIRS					\bigcirc			Ŏ			Ŏ			Ŏ			
LIVING ROOM		\bigcirc					\bigcirc			\bigcirc							
KITCHEN/DINING	\bigcirc						\bigcirc			\bigcirc			C				
CORRIDORS		\bigcirc					\bigcirc			\bigcirc			\bigcirc				
HALF BATHROOM			\bigcirc					\bigcirc		\bigcirc			C				
1ST-2ND FLOOR STAIRS		\bigcirc					\bigcirc			\bigcirc			\bigcirc				
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WIN	idow sch	EDl
TYPE	MATERIAL	MAN
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B	WD	MA
Ċ	WD	MA
	WD	MA
E	WD	MA
F	WD	MA
G	WD	MA
5-4"		
3:-4"	3'-4"	

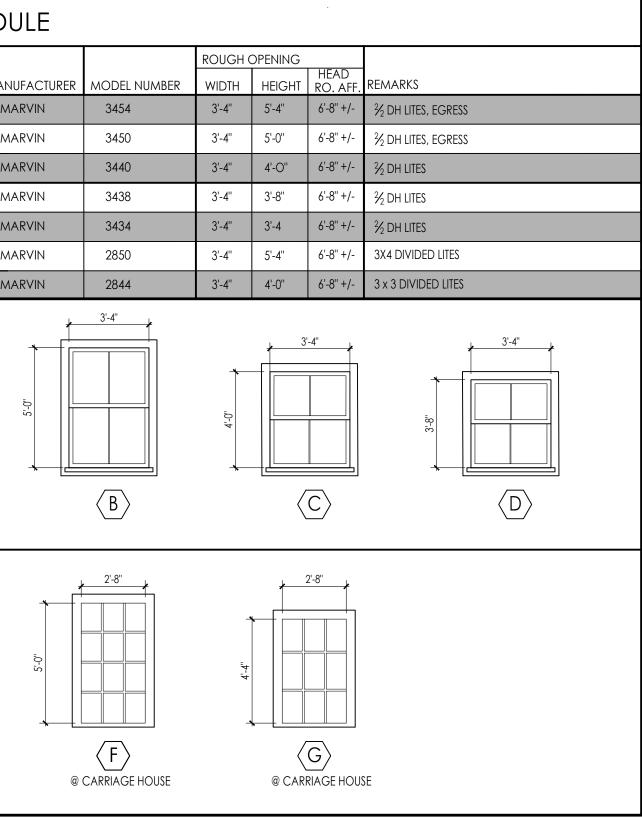

ARCHITECT:	<u> </u>
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	ACL ACL
	ET IASS SALC
	ER. N 0533 0533
DIXON SALC	O SO MAIN STREET WORCESTER, MA (1)508.755.0533 ADMIN@DIXONSA
	0 MAIN 00 MAIN 0508.755 068.755 068.755
INCORPORATE	
ARCHITECT'S STAMP:	
ENGINEER:	
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ENGINEER'S STAMP:	
GENERAL INFORMATION:	
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